SITE ADDRESS

24-30 KENNY STREET, WOLLONGONG LOTS 1-2 D.P. 543836

SITE AREA

2466 sqm TOTAL

FSR

SUMMARY

TOTAL ALLOWABLE

TOTAL PROPOSED ALLOWABLE

COMMON OPEN SPACE AREA

PROPOSED

REQUIRED 616.5 sqm (25%) PROPOSED 852.0 sqm (34%)

4.29:1

4.29:1

10590.60 sqm

10589.12 sqm

CARPARKING REQUIRED

68 RESIDENTIAL (0.6 SPACES PER 1 BED) (1.4 SPACES PER 3 BED)

15 VISITORS

(0.2 SPACES PER UNIT) 04 CAFE / COMMERCIAL (1 SPACE PER 25 SQM)

28 HOTEL (0.5 SPACES PER HOTEL ROOM)

03 HOTEL STAFF (0.25 SPACES PER STAFF MEMBER)

CARPARKING PROVIDED

68 RESIDENTIAL 15 VISITORS

04 CAFE / COMMERCIAL 28 HOTEL

03 HOTEL STAFF

MOTORBIKE SPACES PROVIDED

05 RESIDENTIAL (1 PER 15 UNITS) 00 VISITORS (NIL REQUIRED) 01 COMMERCIAL (1 PER 25 CARS)

02 HOTEL (1 PER 25 CARS)

BICYCLE SPACES PROVIDED

26 RESIDENTIAL (1 PER 3 UNITS = 25) VISITOR (1 PER 12 UNITS = 7) COM / HOTEL STAFF (1 PER 200 SQM = 1)

01 COM / HOTEL VISITOR (1 PER 750 SQM = 1)

70% OF UNITS (53 OUT OF 75 UNITS) REQUIRED TO ACHIEVE SOLAR COMPLIANCE (ADG) TOTAL PROVIDED = 65 UNITS (86.76%)

60% OF UNITS (45 OUT OF 75 UNITS) REQUIRED TO ACHIEVE CROSS VENTILATION (ADG) TOTAL PROVIDED = 46 UNITS (61.33%)

10% OF UNITS (8 UNITS) REQUIRED TO BE ADAPTABLE 20% OF UNITS (15 UNITS) REQUIRED TO ACHIEVE SILVER (LIVABLE HOUSING)

TOTAL ADAPTABLE PROVIDED - 8 UNITS (606, 706, 806, 906, 1006, 1106, 1206, 1306) TOTAL LIVABLE PROVIDED -

15 UNITS (606, 706, 806, 906, 1006, 1106, 1206, 1306) (603, 703, 803, 903, 1003, 1103, 1203)

(NOTE: SINCE 10% OF THE UNITS ALREADY COMPLY WITH ADAPTABLE UNIT REQUIREMENTS THESE UNITS ARE ALSO CAPABLE OF SATISFYING THE INTENT OF SILVER LEVEL OF LIVABLE HOUSING GUIDELINES).

DISCLAIMER

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All parking and ramps to traffic engineers details. (Subject to Approva

AMENDMENT DA SUBMISSION 02.12.2021 24.06.2022 CLIENT REVIEW 04.07.2022 ADDITIONAL INFORMATION 13.07.2022 PRELIMINARY ADD INFO DESIGN WORKSHOP AUSTRALIA

AREA SCHEDULE (GFA)

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LEVEL	AREA	FSR
ROUND FL	590.89 m²	0.24
EVEL 1	1089.38 m²	0.44
EVEL 2	1090.06 m ²	0.44
EVEL 3	810.57 m ²	0.33
EVEL 4	86.42 m²	0.04
EVEL 5	607.20 m ²	0.25
EVEL 6	607.20 m ²	0.25
EVEL 7	607.20 m ²	0.25
EVEL 8	607.20 m ²	0.25
EVEL 9	607.20 m ²	0.25
EVEL 10	607.20 m ²	0.25
EVEL 11	607.20 m ²	0.25
EVEL 12	607.20 m ²	0.25
EVEL 13	607.20 m ²	0.25
EVEL 14	504.92 m ²	0.20
EVEL 15	504.92 m ²	0.20
EVEL 16	320.68 m ²	0.13
EVEL 17	126.46 m²	0.05
	10589.12 m²	4.29



AREA TYPE BREAKDOWN (GFA)

LEVEL	AREA	FSR
COMMERCIAL		
GROUND FL	375.86 m ²	0.15
LEVEL 1	1089.38 m²	0.44
LEVEL 2	1090.06 m ²	0.44
LEVEL 3	810.57 m ²	0.33
	3365.88 m²	1.36

	3365.88 m²	1.36
RESIDENTIAL		
GROUND FL	215.02 m ²	0.09
LEVEL 4	86.42 m²	0.04
LEVEL 5	607.20 m ²	0.25
LEVEL 6	607.20 m ²	0.25
LEVEL 7	607.20 m ²	0.25
LEVEL 8	607.20 m ²	0.25
LEVEL 9	607.20 m ²	0.25
LEVEL 10	607.20 m ²	0.25
LEVEL 11	607.20 m ²	0.25
LEVEL 12	607.20 m ²	0.25
LEVEL 13	607.20 m ²	0.25
LEVEL 14	504.92 m ²	0.20
LEVEL 15	504.92 m ²	0.20
LEVEL 16	320.68 m²	0.13
LEVEL 17	126.46 m²	0.05
	7223.25 m ²	2.93

10589 12 m²

4.29

033 SITE CONTEXT - KEY 040 ELEVATION - EAST 041 ELEVATION - SOUTH 042 ELEVATION - WEST 043 ELEVATION - NORTH SITE CONTEXT - KEY FLOOR PLANS SECTION A 051 SECTION B 052 SECTION C SECTION D SITE SECTION E 3D PERSPECTIVE (FRONT 3D PERSPECTIVE (REAR 3D PERSPECTIVES 3D PERSPECTIVES 065 3D PERSPECTIVE (HEIGHT PLANE) 070 SHADOWS - WINTER SHADOWS - WINTER SHADOWS - WINTER SHADOWS SUMMER ADJACENT DEVELOPMENT ANALYSIS (COMM) ADJACENT DEVELOPMENT ANALYSIS (COMM) ADJACENT DEVELOPMENT AMALYSIS (SHADOWS) ADJACENT DEVELOPMENT ANALYSIS (SHADOWS)

DRAWING LIST

SHEET NAME

NO.

 001
 DCP ANALYSIS

 002
 REGIONAL CONTEXT

 003
 LOCAL CONTEXT

009 SURVEY 009a DETAILED SURVEY 010 DEMOLITION PLAN

013 BASEMENT 2 PLAN

014 BASEMENT 1 PLAN 015 GROUND FLOOR PLAN 016 LEVEL 1 PLAN

021 LEVEL 6-13 PLAN (TYPICAL)

011 PRECEDENCE 012 SITE PLAN

017 LEVEL 2 PLAN

018 LEVEL 3 PLAN 019 LEVEL 4 PLAN 020 LEVEL 5 PLAN

022 LEVEL 14 PLAN
023 LEVEL 15 PLAN
024 LEVEL 16 PLAN

025 LEVEL 17 PLAN

ROOF PLAN

GFA PLANS

UNIT KEY PLAN

SITE CONTEXT - KEY FLOOR PLANS

SITE CONTEXT - KEY FLOOR PLANS

SITE CONTEXT - KEY FLOOR PLANS

029 STORAGE SCHEDUL

DETAILED CONTEXTUAL ANALYSIS 005 CONTEXTUAL STREETSCAPE ANALYSIS 006 CONTEXTUAL STREETSCAPE ANALYSIS

SURROUNDING CONTEXTUAL ANALYSIS 008 SURROUNDING CONTEXTUAL ANALYSIS

НОТЕ	L ROOM SCHE	DULE
LEVEL	NAME	QTY
LEVEL 1	HOTEL ROOM	19
LEVEL 2	HOTEL ROOM	21
LEVEL 3	HOTEL ROOM	16
TOTAL NO. ROOMS 56		

ADJACENT DEVELOPMENT ANALYSIS (SHADOWS) ADJACENT DEVELOPMENT ANALYSIS (COS) 086 ADJACENT DEVELOPMENT ANALYSIS (COS)

ADJACENT DEVELOPMENT ANALYSIS (SOLAR)


088 ADJACENT DEVELOPMENT ANALYSIS (SOLAR)
089 ADJACENT DEVELOPMENT ANALYSIS (SOLAR)

CROSS VENTILATION

093 SOLAR ACCESS VIEWS SOLAR CALCULATIONS

MIXED USE DEVELOPMENT

24-30 KENNY STREET, WOLLONGONG, NSW **BLAQ PROJECTS**

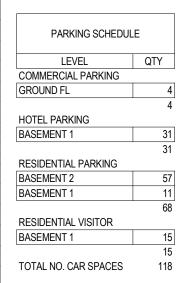


UNIT TYPE SCHEDULE		
TYPES NO OF ROOMS		
1 BED	11	
2 BED	58	
3 BED	4	
4 BED 2		
TOTAL 75		



DISCIPLINE	CONSULTANTS	CONTACT	PH.	EMAIL.
ARCHITECT	DESIGN WORKSHOP AUSTRALIA	ROBERT GIZZI	02 4227 1661	robert@designworkshop.com.au
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SURVEYOR	CEH CONSULTING	MATTHEW SMITH	02 4261 4366	msmith@cehconsulting.com.au
TRAFFIC / DRAINAGE	ATB CONSULTING ENGINEERS	GORAN UGRINOVSKI	0414 622 844	goran@atbconsulting.com.au
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BCA CONSULTANT	BUILDING CODE ASSISTANCE	PETER DIX	0407 270 908	peter@buildingcodeassistance.com.au
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WASTE CONSULTANT	DICKENS SOLUTIONS	GARRY DICKENS	0400 388 996	garry@dickenssolutions.com.au
WIND CONSULTANT	ANA CIVIL	SAMAR BAZZI	02 9793 1393	admin@anacivil.com
QUANTITY SURVEYOR	РВА	ANGELO ANTIDORMI	0418 455 294	info@pbaqs.com.au


ADDITIONAL INFORMATION

ANYA SOLUTION Pty Ltd Wollongong Sydney CLIENT: ISSUE DATE: PROJECT No. MIXED USE DEVELÓPMENT 28.11.2022 81a Princes Highway Level 10, 6 Mount 2289 airy Meadow NSW 2519 DRAWN: AK/SL/ML Olympus Boulevard ADDRESS 24-30 KENNY STREET Tel: (02) 4227 1661 DWG No Rev SCALE: WOLLONGONG, NSW Email: info@designworkshop.com.au Nominated Architect QA: 000 BB Web: www.designworkshop.com.au Robert Gizzi (Reg. 8286) DRAWING NAME: COVERSHEET

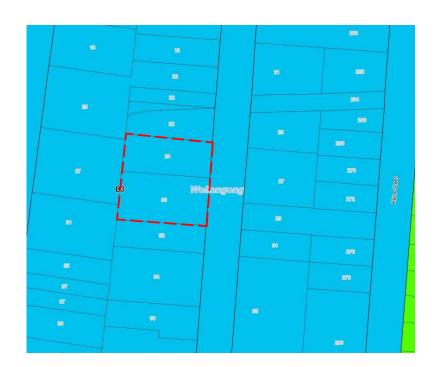


ZONING MAP

B3 - COMMERCIAL CORE

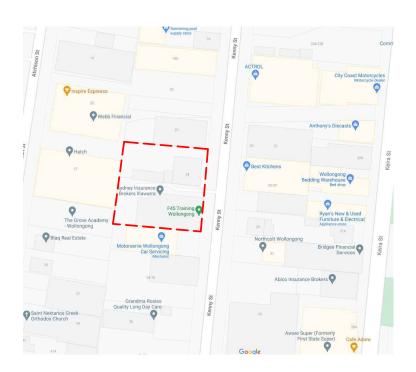

SITE MAP

24-30 KENNY STREET, WOLLONGONG

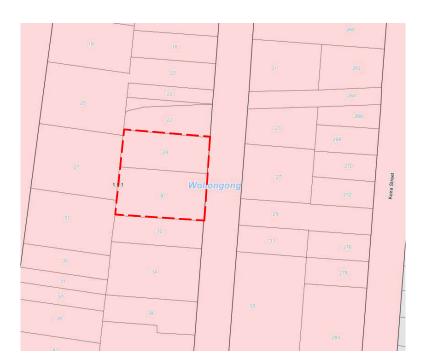

FSR

SEE WOLLONGONG DCP AND COVERSHEET FOR FSR CALCULATIONS



BUILDING HEIGHT

60 METRE HEIGHT LIMIT



STREET VIEW

24-30 KENNY STREET, WOLLONGONG

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REF.	DATE	AMENDMENT
N	06.09.2021	CONSULTANT ISSUE
P	04.11.2021	CONSULTANT ISSUE
Q	02.12.2021	DA SUBMISSION
U	04.07.2022	ADDITIONAL INFORMATION
w	19.07.2022	ADDITIONAL INFORMATION
DISCLAIMER		

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Wollongong 81a Princes Highway, Fairy Meadow NSW 2519 Tel: (02) 4227 1661 Email: info@designworkshop.com.au

Sydney Level 10, 6 Mount Olympus Boulevard, Wolli Creek NSW 2205 Nominated Architect: Robert Gizzi (Reg. 8286)

CLIENT:

ANYA SOLUTION Pty Ltd MIXED USE DEVELOPMENT 24-30 KENNY STREET, WOLLONGONG, NSW

DRAWING NAME: DCP ANALYSIS

ADDITIONAL INFORMATION





REGIONAL CONTEXT

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AMENDMENT
CONSULTANT ISSUE
CONSULTANT ISSUE
DA SUBMISSION 06.09.2021 04.11.2021 02.12.2021 ADDITIONAL INFORMATION 04.07.2022 nt of any work. DESIGN WORKSHOP AUSTRALIA

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Wollongong 81a Princes Highway, Fairy Meadow NSW 2519 Tel: (02) 4227 1661 Email: info@designworkshop.com.au Sydney Level 10, 6 Mount Olympus Boulevard, Wolli Creek NSW 2205 Nominated Architect: Robert Gizzi (Reg. 8286)

ANYA SOLUTION Pty Ltd MIXED USE DEVELOPMENT CLIENT: 24-30 KENNY STREET, WOLLONGONG, NSW

DRAWING NAME: REGIONAL CONTEXT

PROPOSED DEVELOPMENT

BEACHES

LOCAL SHOPS


ENTERTAINMENT AREAS

LEGEND EDUCATION FACILITY PARKS AND RECREATION AREAS

PUBLIC TRANSPORT FACILITIES MEDICAL FACILITIES

HERITAGE ITEMS

ADDITIONAL INFORMATION

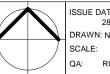

ISSUE DATE: 28.11.2022


Rev.

PROJECT No.

2289

DWG No.



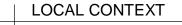

AMENDMENT
CONSULTANT ISSUE
CONSULTANT ISSUE
DA SUBMISSION 06.09.2021 04.11.2021 02.12.2021 ADDITIONAL INFORMATION 04.07.2022

Wollongong 81a Princes Highway, Fairy Meadow NSW 2519 Tel: (02) 4227 1661 Email: info@designworkshop.com.au

Web: www.designworkshop.com.au

Sydney Level 10, 6 Mount Olympus Boulevard, Wolli Creek NSW 2205 Nominated Architect: Robert Gizzi (Reg. 8286)

ANYA SOLUTION Pty Ltd MIXED USE DEVELOPMENT CLIENT:

24-30 KENNY STREET, WOLLONGONG, NSW DRAWING NAME: LOCAL CONTEXT

LEGEND

PROPOSED DEVELOPMENT

ENTERTAINMENT AREAS

PARKS AND RECREATION AREAS

BEACHES LOCAL SHOPS

PUBLIC TRANSPORT FACILITIES MEDICAL FACILITIES

HERITAGE ITEMS


EDUCATION FACILITY

ADDITIONAL INFORMATION



ISSUE DATE: SCALE:

PROJECT No. 2289 DWG No. Rev. 003 ВВ

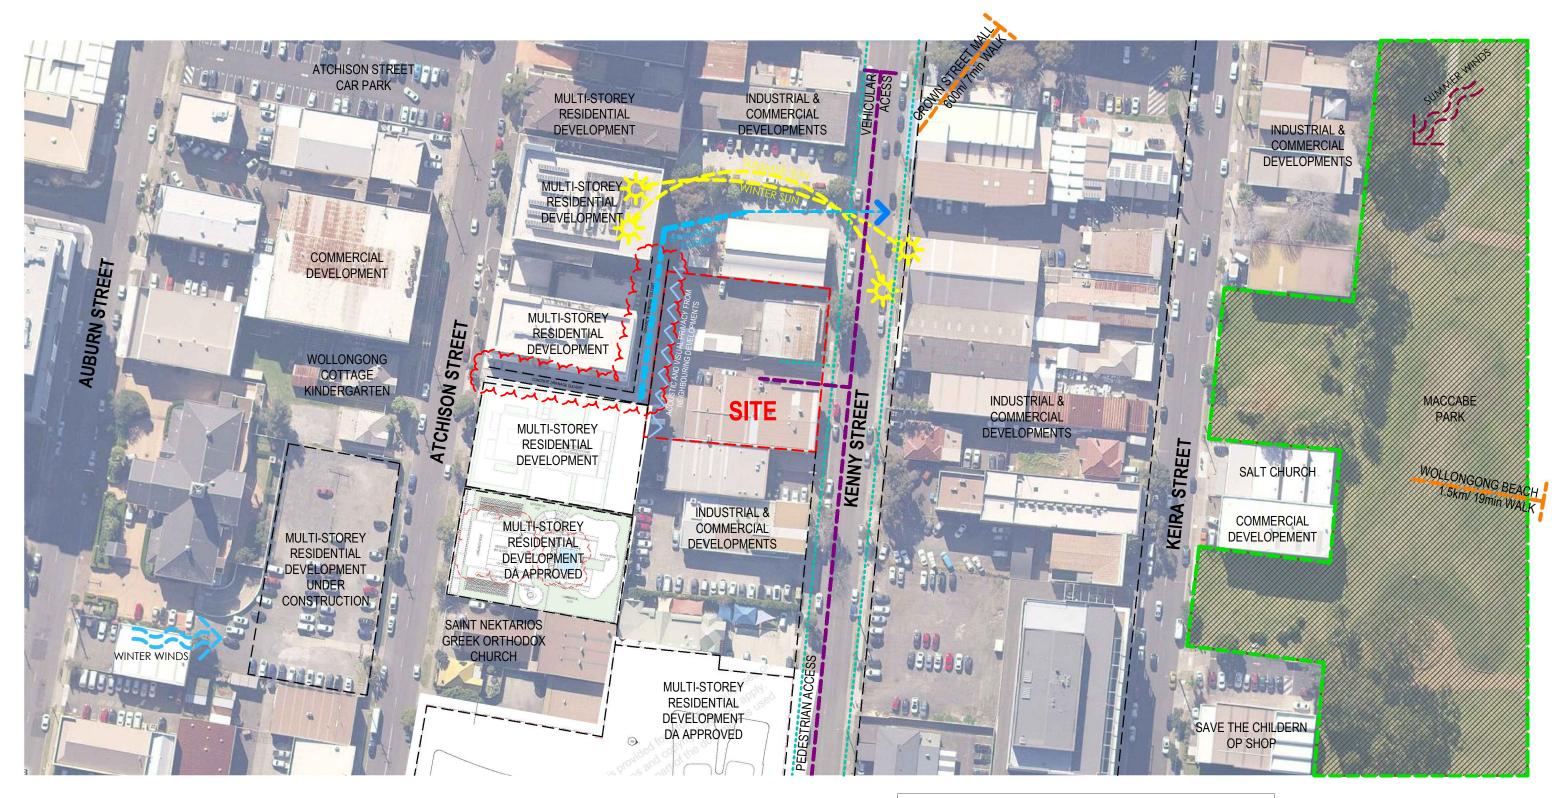

DETAILED CONTEXTUAL ANALYSIS

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AMENDMENT CONSULTANT ISSUE 06.09.2021 04.11.2021 02.12.2021 CONSULTANT ISSUE DA SUBMISSION ADDITIONAL INFORMATION 04.07.2022 DESIGN WORKSHOP AUSTRALIA

Wollongong 81a Princes Highway airy Meadow NSW 2519 Tel: (02) 4227 1661 Email: info@designworkshop.com.au

Sydney Level 10, 6 Mount Olympus Boulevard, Wolli Creek NSW 2205 Nominated Architect Web: www.designworkshop.com.au Robert Gizzi (Reg. 8286)

ANYA SOLUTION Pty Ltd MIXED USE DEVELOPMENT CLIENT: ADDRESS

24-30 KENNY STREET, WOLLONGONG, NSW

DRAWING NAME: DETAILED CONTEXTUAL ANALYSIS

LEGEND

PROPOSED DEVELOPMENT

PARKS AND RECREATION AREAS

BEACHES LOCAL SHOPS

ENTERTAINMENT AREAS

EDUCATION FACILITY PUBLIC TRANSPORT FACILITIES

MEDICAL FACILITIES


HERITAGE ITEMS


ADDITIONAL INFORMATION



ISSUE DATE: 28.11.2022 SCALE: QA:

PROJECT No. 2289 DWG No. Rev 004 ΒB

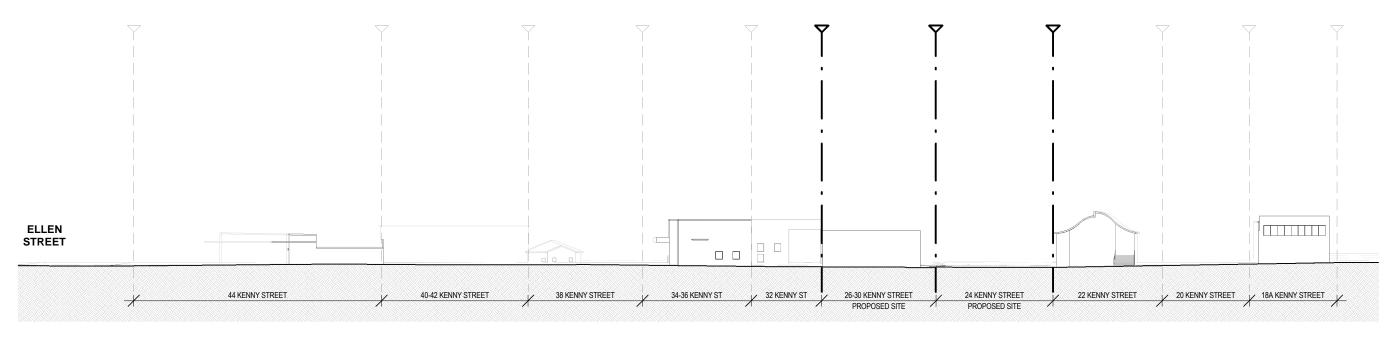

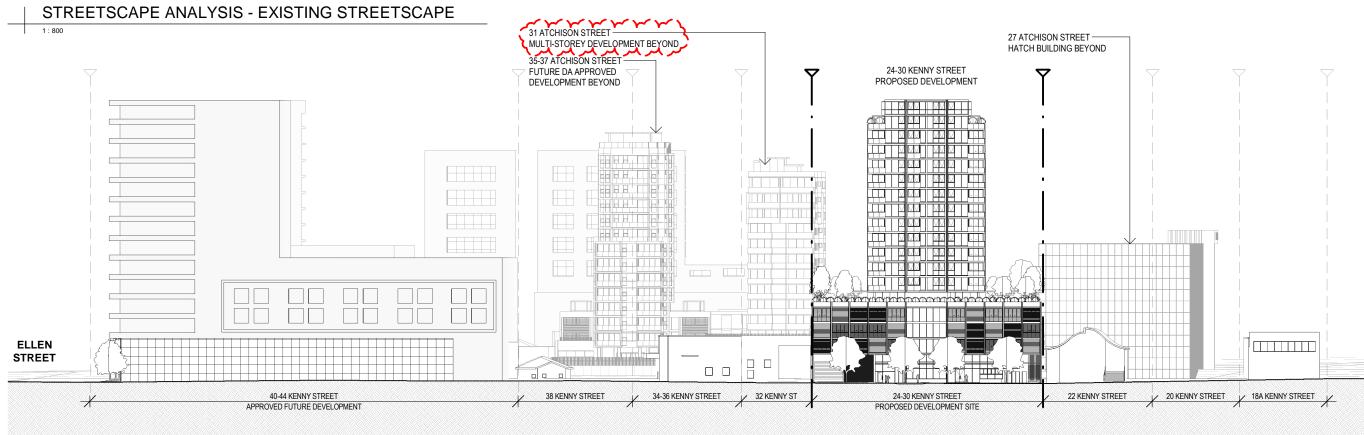

STREETSCAPE ANALYSIS - PROPOSED STREETSCAPE 1:800

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All partings and ramps to traffic engineers details. (Subject to Approval)

All parking	and ramps to traffi	c engineers details. (Subject to Appr	ovai)
REF.	DATE	AMENDMENT	
N	06.09.2021	CONSULTANT ISSUE	
P	04.11.2021	CONSULTANT ISSUE	
Q	02.12.2021	DA SUBMISSION	
U	04.07.2022	ADDITIONAL INFORMATION	
W	19.07.2022	ADDITIONAL INFORMATION	
DISCLAIN			
		imensions on site prior to commencement of any work.	DESIGN WORKSHOP AUSTRA

Web: www.designworkshop.com.au

Wollongong 81a Princes Highway, Fairy Meadow NSW 2519 Tel: (02) 4227 1661 Email: info@designworkshop.com.au

Sydney Level 10, 6 Mount Olympus Boulevard, Wolli Creek NSW 2205 Nominated Architect: Robert Gizzi (Reg. 8286)


CLIENT: DRAWING NAME: CONTEXTUAL STREETSCAPE ANALYSIS

ANYA SOLUTION Pty Ltd MIXED USE DEVELOPMENT ADDRESS:

24-30 KENNY STREET, WOLLONGONG, NSW

ADDITIONAL INFORMATION ISSUE DATE: PROJECT No. 28.11.2022

2289 DRAWN: NT DWG No. Rev. SCALE: 005 BB QA: RG

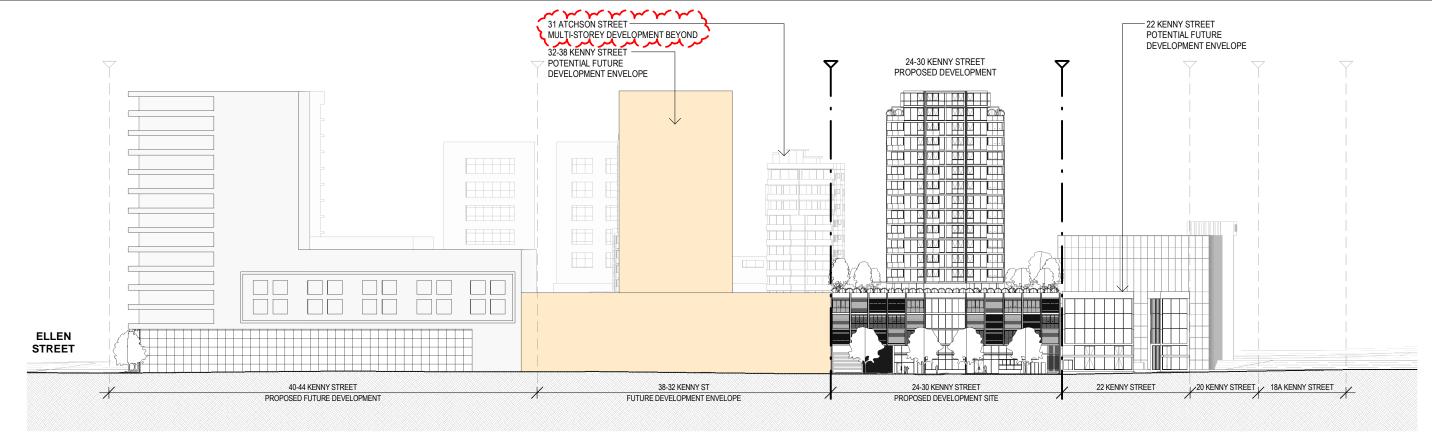

STREETSCAPE ANALYSIS - FUTURE (OPTION A)

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AMENDMENT CONSULTANT ISSUE DATE 06.09.2021 04.11.2021 02.12.2021 CONSULTANT ISSUE DA SUBMISSION ADDITIONAL INFORMATION 04.07.2022

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Wollongong 81a Princes Highway, Fairy Meadow NSW 2519 Tel: (02) 4227 1661

Sydney Level 10, 6 Mount Olympus Boulevard, Wolli Creek NSW 2205 Email: info@designworkshop.com.au Nominated Architect: Web: www.designworkshop.com.au Robert Gizzi (Reg. 8286)


DRAWING NAME: CONTEXTUAL STREETSCAPE ANALYSIS

ANYA SOLUTION Pty Ltd MIXED USE DEVELOPMENT CLIENT: ADDRESS:


24-30 KENNY STREET, WOLLONGONG, NSW

ADDITIONAL INFORMATION

PROJECT No. ISSUE DATE: 28.11.2022 2289 DRAWN: NT DWG No. Rev. SCALE: 006 BB QA: RG

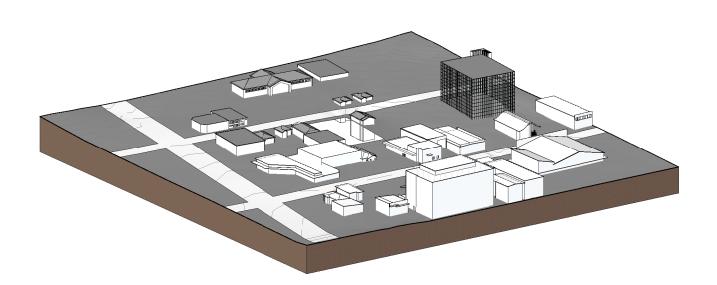

CONTEXTUAL 3D VIEW ANALYSIS - EXISTING - VIEW 1

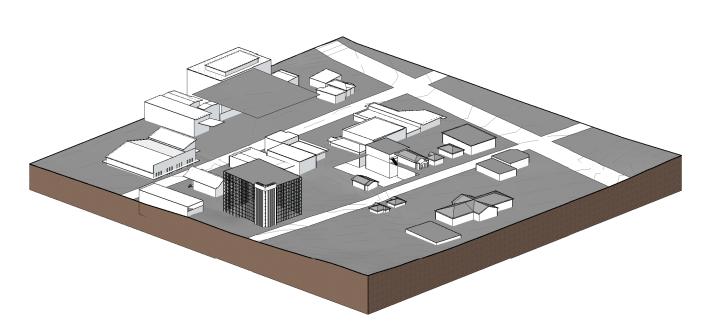

CONTEXTUAL 3D VIEW ANALYSIS - EXISTING - VIEW 2

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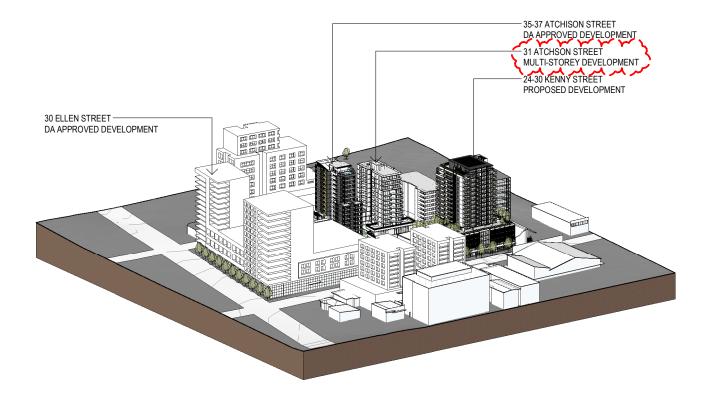
Sydney Level 10, 6 Mount Olympus Boulevard, Wolli Creek NSW 2205 Nominated Architect: Robert Gizzi (Reg. 8286) DRAWING NAME: SURROUNDING CONTEXTUAL ANALYSIS

CLIENT: ADDRESS:


24-30 KENNY STREET, WOLLONGONG, NSW


ANYA SOLUTION Pty Ltd MIXED USE DEVELOPMENT

ADDITIONAL INFORMATION




CONTEXTUAL 3D VIEW ANALYSIS - PROPOSED - VIEW 1

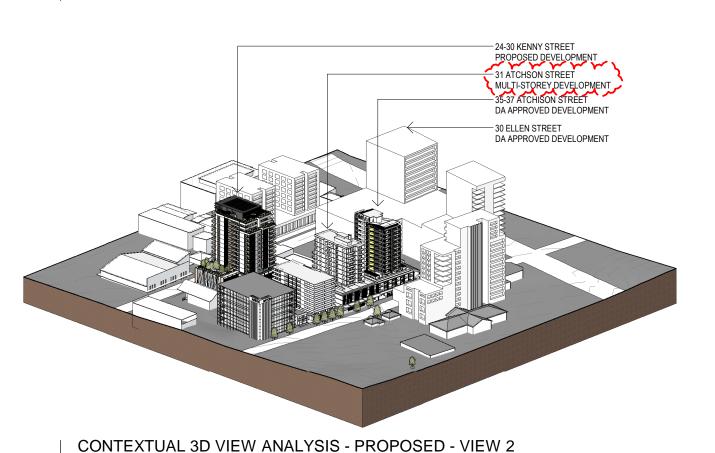

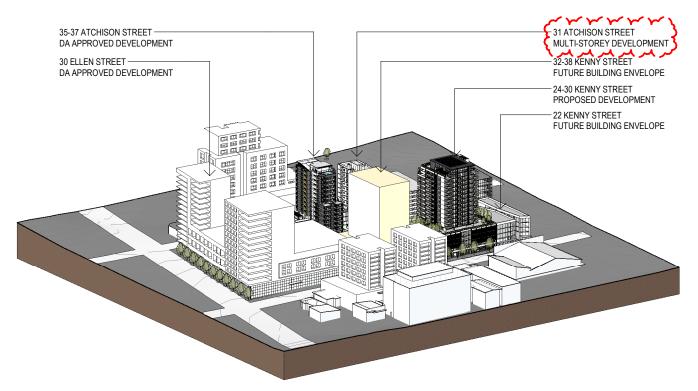

CONTEXTUAL 3D VIEW ANALYSIS - FUTURE (OPTION A) - VIEW 1

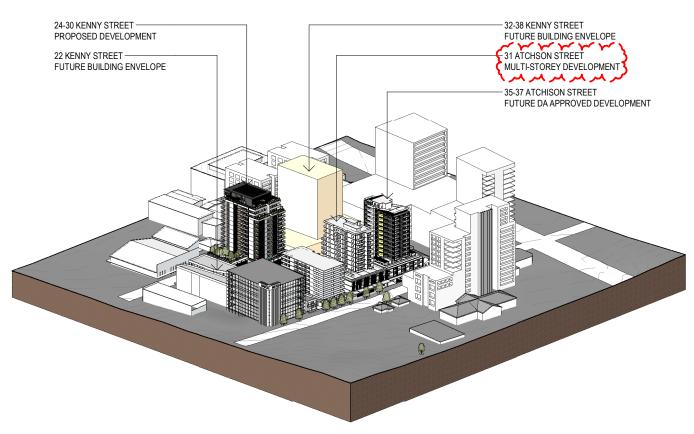

CONTEXTUAL 3D VIEW ANALYSIS - FUTURE (OPTION A) - VIEW 2

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AMENDMENT CONSULTANT ISSUE 06.09.2021 04.11.2021 02.12.2021 CONSULTANT ISSUE DA SUBMISSION ADDITIONAL INFORMATION 04.07.2022

DESIGN WORKSHOP AUSTRALIA

Wollongong 81a Princes Highway, Fairy Meadow NSW 2519

Tel: (02) 4227 1661 Email: info@designworkshop.com.au Web: www.designworkshop.com.au Sydney Level 10, 6 Mount Olympus Boulevard, Wolli Creek NSW 2205 Nominated Architect: Robert Gizzi (Reg. 8286)

CLIENT: ADDRESS:


ANYA SOLUTION Pty Ltd MIXED USE DEVELOPMENT

DRAWING NAME: SURROUNDING CONTEXTUAL ANALYSIS

24-30 KENNY STREET, WOLLONGONG, NSW


ADDITIONAL INFORMATION

ISSUE DATE: PROJECT No. 28.11.2022 2289 DRAWN: NT DWG No. Rev. SCALE: 800 BB QA: RG

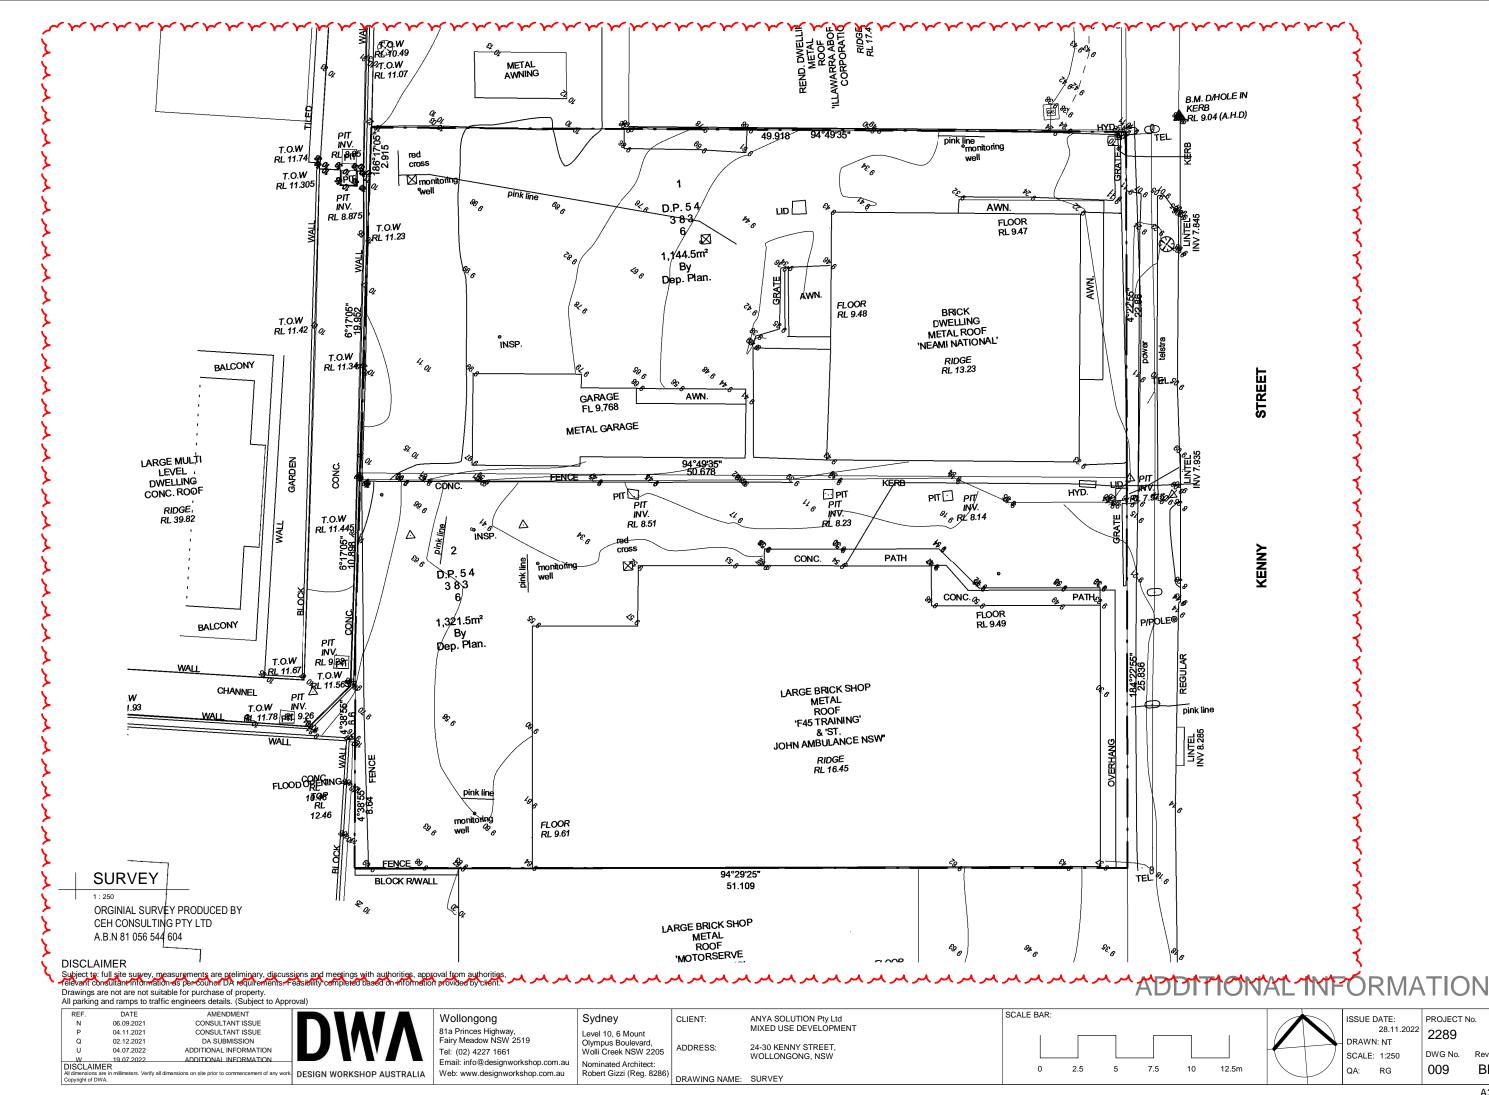

BB

Rev.

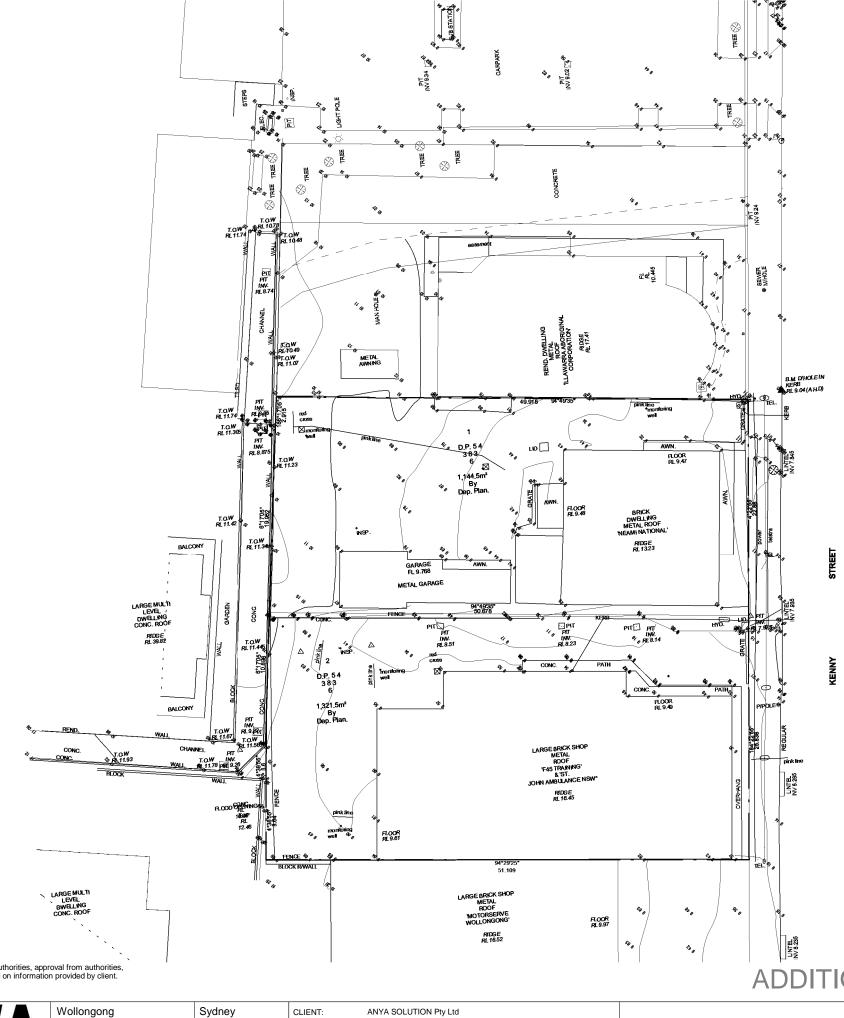

DETAILED SURVEY

ORGINIAL SURVEY PRODUCED BY CEH CONSULTING PTY LTD A.B.N 81 056 544 604

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25.11.2022 28.11.2022

AMENDMENT ADDITIONAL INFORMATION ADDITIONAL INFORMATION

81a Princes Highway, Fairy Meadow NSW 2519 Tel: (02) 4227 1661 Email: info@designworkshop.com.au Web: www.designworkshop.com.au Sydney Level 10, 6 Mount Olympus Boulevard, Wolli Creek NSW 2205 Nominated Architect: Robert Gizzi (Reg. 8286)

ADDRESS:

ANYA SOLUTION Pty Ltd MIXED USE DEVELOPMENT 24-30 KENNY STREET, WOLLONGONG, NSW


DRAWING NAME: DETAILED SURVEY

ADDITIONAL INFORMATION



ISSUE DATE: 28.11.2022 SCALE:

PROJECT No. 2289 (009a ВВ

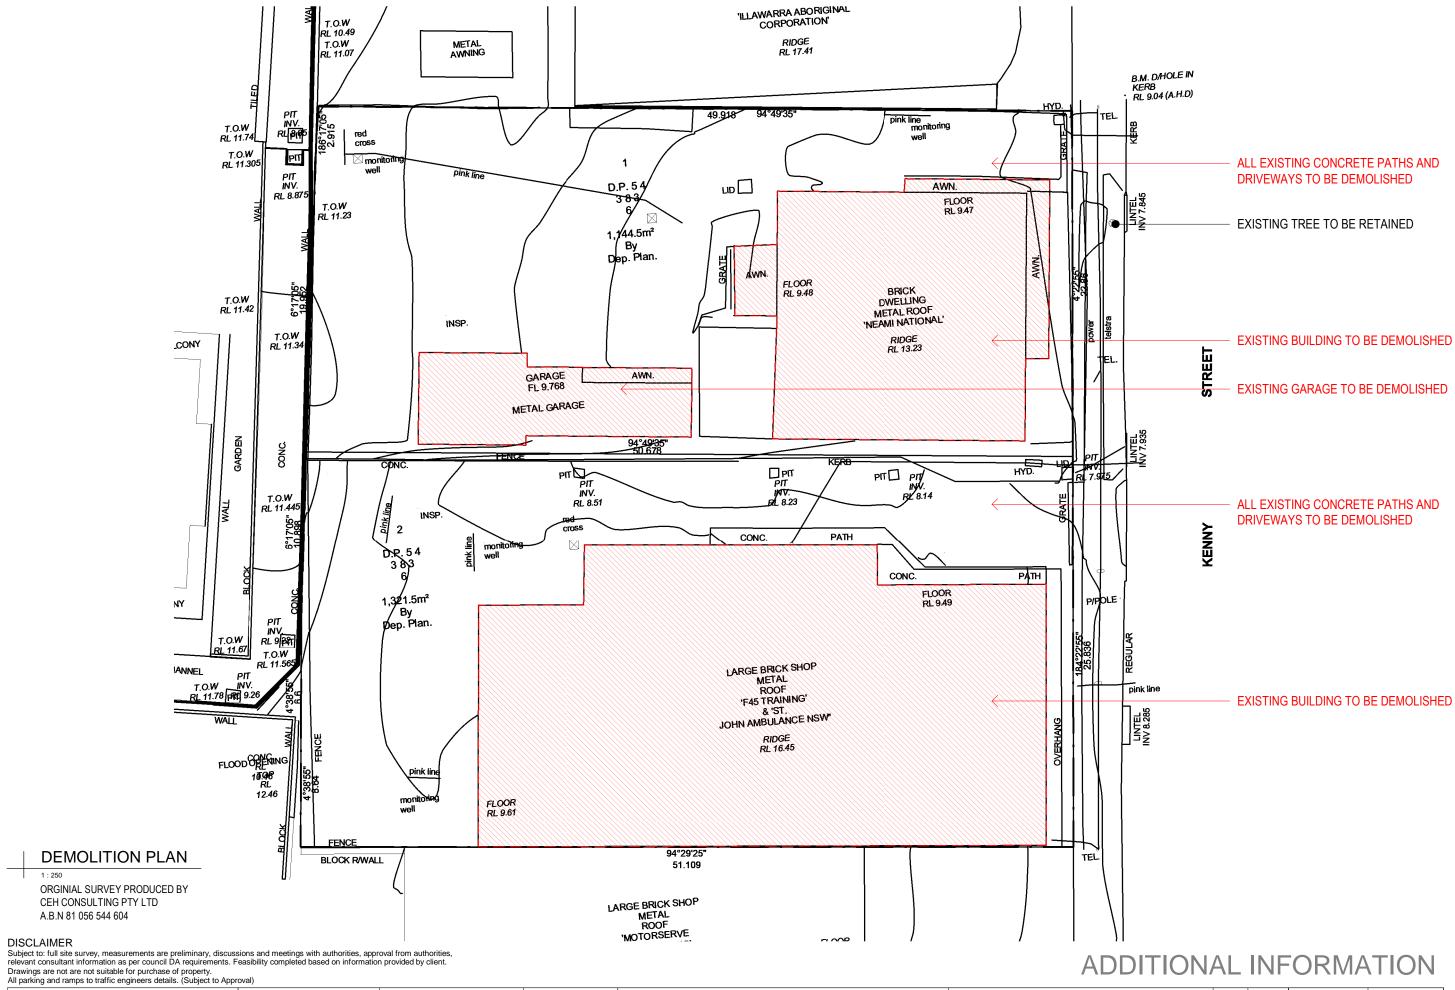

AMENDMENT CONSULTANT ISSUE 06.09.2021 04.11.2021 02.12.2021 CONSULTANT ISSUE DA SUBMISSION ADDITIONAL INFORMATION 04.07.2022 DESIGN WORKSHOP AUSTRALIA

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Web: www.designworkshop.com.au

Sydney Level 10, 6 Mount Olympus Boulevard, Wolli Creek NSW 2205 Nominated Architect: Robert Gizzi (Reg. 8286)

ANYA SOLUTION Pty Ltd MIXED USE DEVELOPMENT CLIENT: 24-30 KENNY STREET, WOLLONGONG, NSW ADDRESS:

DRAWING NAME: DEMOLITION PLAN


















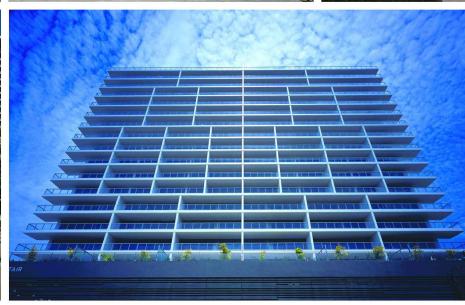









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CONSULTANT ISSUE
CONSULTANT ISSUE
DA SUBMISSION
ADDITIONAL INFORMATION 06.09.2021 04.11.2021 02.12.2021 04.07.2022 W 19.07.2022 ADDITIONAL INFORMATION
DISCLAIMER
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Email: info@designworkshop.com.au
Web: www.designworkshop.com.au

Wollongong 81a Princes Highway, Fairy Meadow NSW 2519 Tel: (02) 4227 1661

Nominated Architect:

CLIENT: Level 10, 6 Mount Olympus Boulevard, Wolli Creek NSW 2205


Sydney

ANYA SOLUTION Pty Ltd MIXED USE DEVELOPMENT 24-30 KENNY STREET, WOLLONGONG, NSW

ADDRESS: Robert Gizzi (Reg. 8286) DRAWING NAME: PRECEDENCE

ADDITIONAL INFORMATION

ISSUE DATE: PROJECT No. 28.11.2022 2289 DRAWN: DQ / AK SCALE: DWG No. Rev. 011 ВВ QA: RG

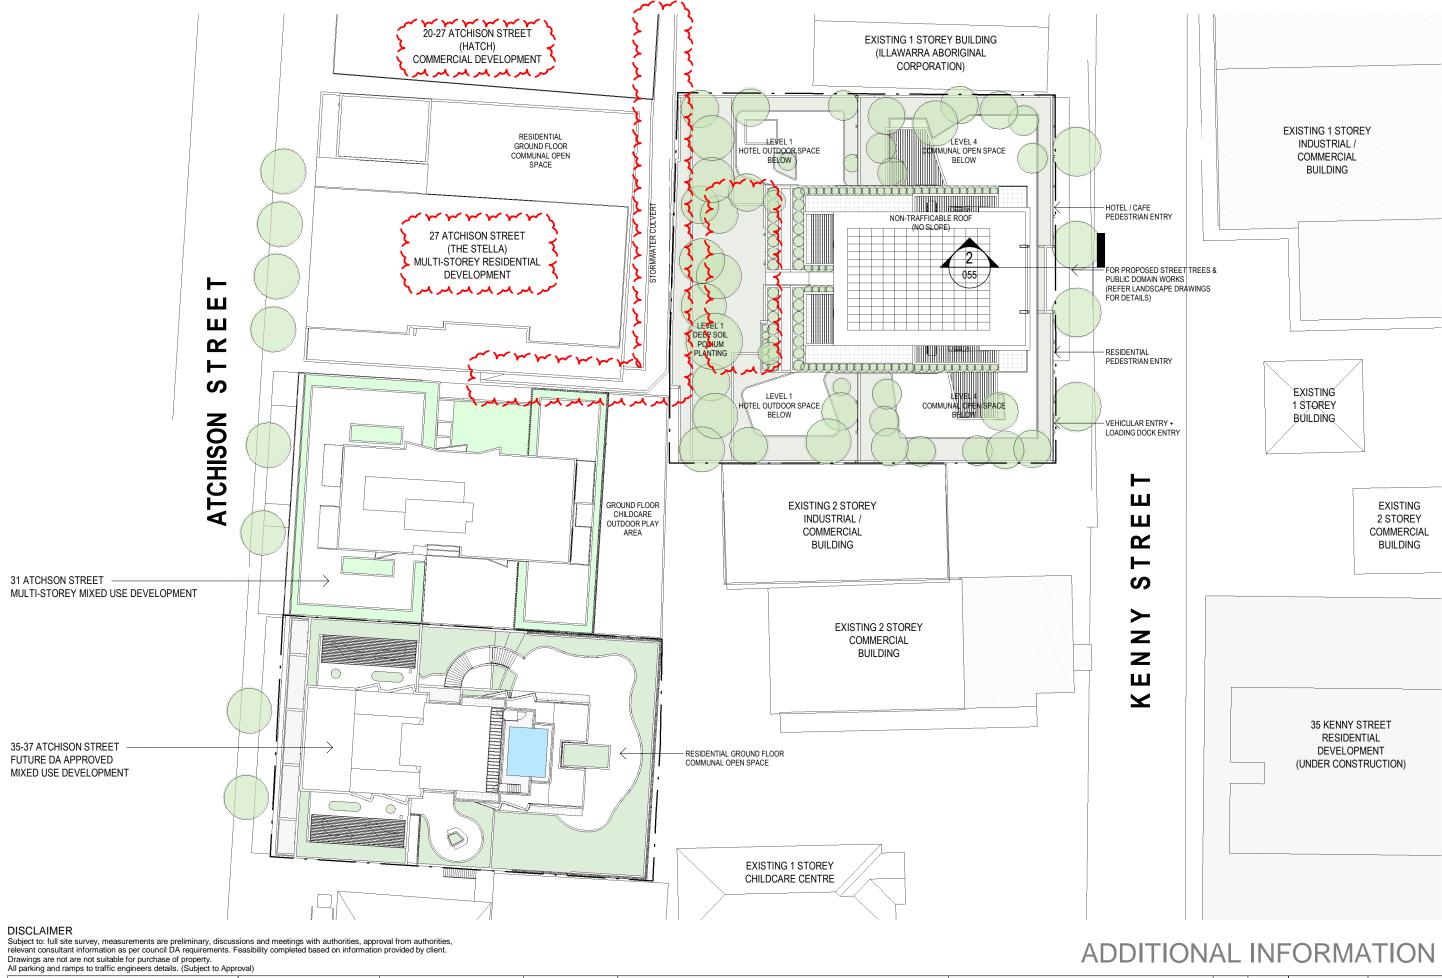

AMENDMENT CONSULTANT ISSUE 04.11.2021 02.12.2021 24.06.2022 DA SUBMISSION CLIENT REVIEW 04.07.2022 ADDITIONAL INFORMATION millimeters. Verify all dimensions on site prior to commencement of any work. DESIGN WORKSHOP AUSTRALIA


Wollongong


81a Princes Highway, Fairy Meadow NSW 2519 Tel: (02) 4227 1661 Email: info@designworkshop.com.au Web: www.designworkshop.com.au

Sydney Level 10, 6 Mount Olympus Boulevard, Wolli Creek NSW 2205 Nominated Architect: Robert Gizzi (Reg. 8286) DRAWING NAME: SITE PLAN

ANYA SOLUTION Pty Ltd MIXED USE DEVELOPMENT CLIENT: 24-30 KENNY STREET, WOLLONGONG, NSW ADDRESS:

SCALE BAR: 10 15 20 25m

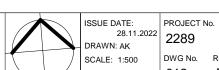

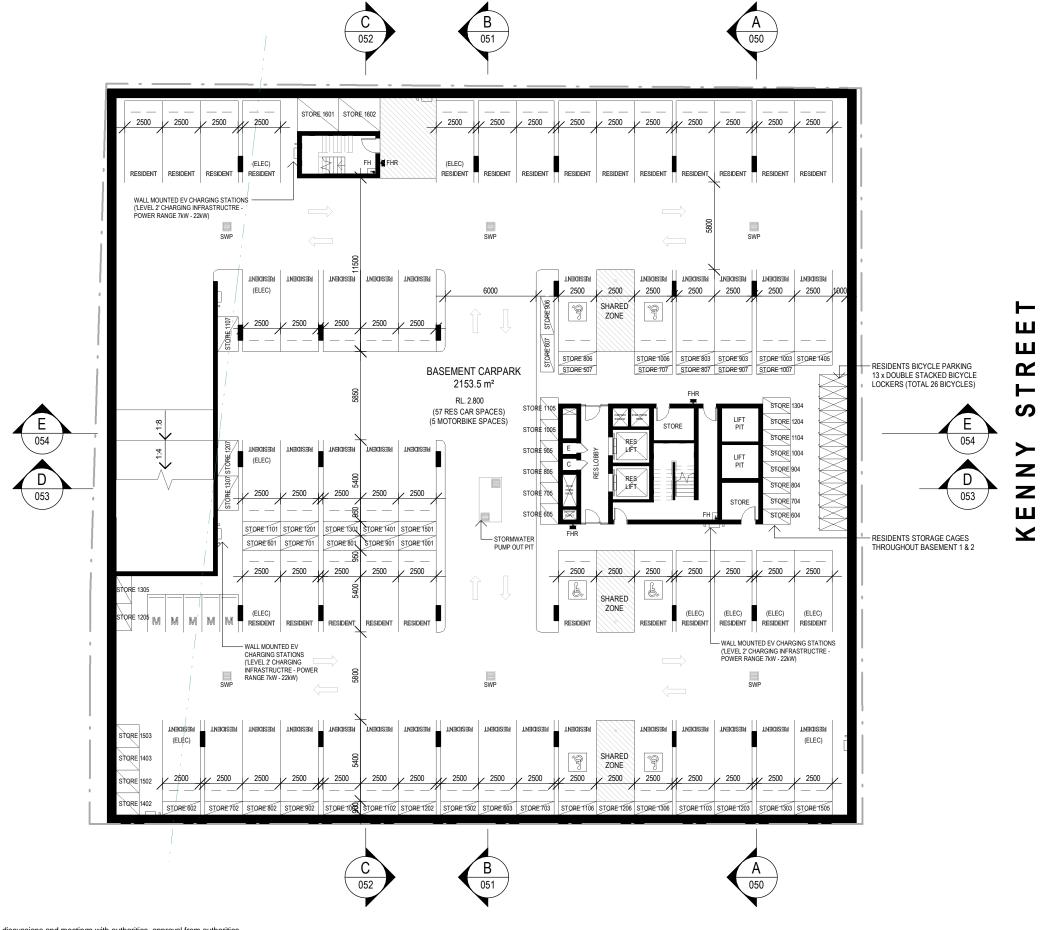

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AMENDMENT DA SUBMISSION DATE 02.12.2021 24.06.2022

CLIENT REVIEW ADDITIONAL INFORMATION 04.07.2022 19.07.2022 ADDITIONAL INFORMATION Z 23.11.2022

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All dimensions are:

All parking and ramps to traffic engineers details. (Subject to Approval n millimeters. Verify all dimensions on site prior to commencement of any work.

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Sydney Level 10, 6 Mount Olympus Boulevard, Wolli Creek NSW 2205 Nominated Architect: Robert Gizzi (Reg. 8286)

CLIENT: ADDRESS:

ANYA SOLUTION Pty Ltd MIXED USE DEVELÓPMENT 24-30 KENNY STREET WOLLONGONG, NSW DRAWING NAME: BASEMENT 2 PLAN

SCALE BAR: 5 7.5 10 12.5m

ADDITIONAL INFORMATION PROJECT No. ISSUE DATE: 28.11.2022 2289 DRAWN: AK/SL/ML


SCALE: 1:250

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Rev.

DWG No.



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REF.	DATE	AMENDMENT
Q	02.12.2021	DA SUBMISSION
T	24.06.2022	CLIENT REVIEW
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w	19.07.2022	ADDITIONAL INFORMATION
Z	23.11.2022	PRELIMINARY
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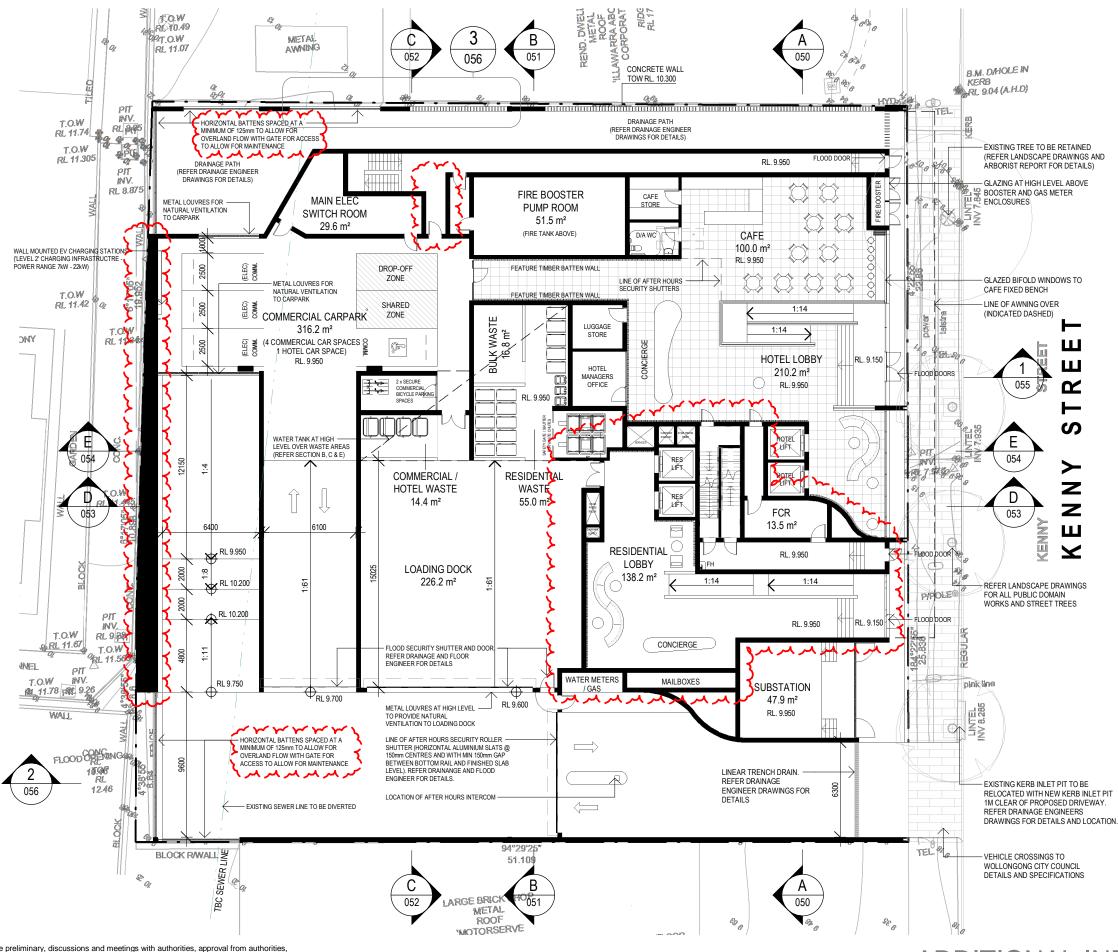
Sydney Level 10, 6 Mount Olympus Boulevard, Wolli Creek NSW 2205 Nominated Architect: Web: www.designworkshop.com.au Robert Gizzi (Reg. 8286)

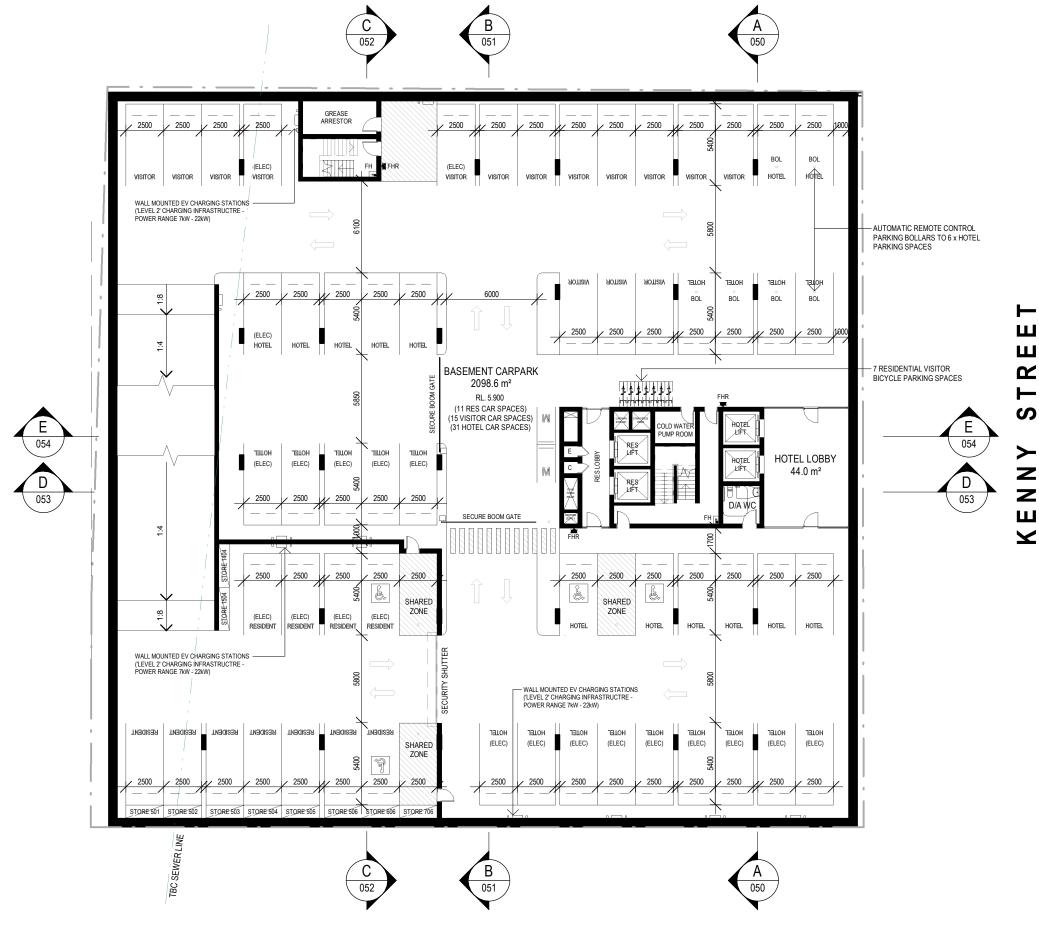CLIENT: ANYA SOLUTION Pty Ltd MIXED USE DEVELÓPMENT ADDRESS: 24-30 KENNY STREET WOLLONGONG, NSW

DRAWING NAME: BASEMENT 1 PLAN

SCALE BAR: 5 7.5 10 12.5m





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REF.	DATE	AMENDMENT		
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Z	23.11.2022	PRELIMINARY		
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Sydney Level 10, 6 Mount Olympus Boulevard, Wolli Creek NSW 2205 Nominated Architect: Web: www.designworkshop.com.au Robert Gizzi (Reg. 8286)

ANYA SOLUTION Pty Ltd CLIENT: MIXED USE DEVELÓPMENT ADDRESS: 24-30 KENNY STREET WOLLONGONG, NSW

DRAWING NAME: GROUND FLOOR PLAN

SCALE BAR: 5 7.5 10 12.5m


ADDITIONAL INFORMATION ISSUE DATE: PROJECT No. 28.11.2022 2289

DRAWN: AK/SL/ML

SCALE: 1:250

Rev.

DWG No.

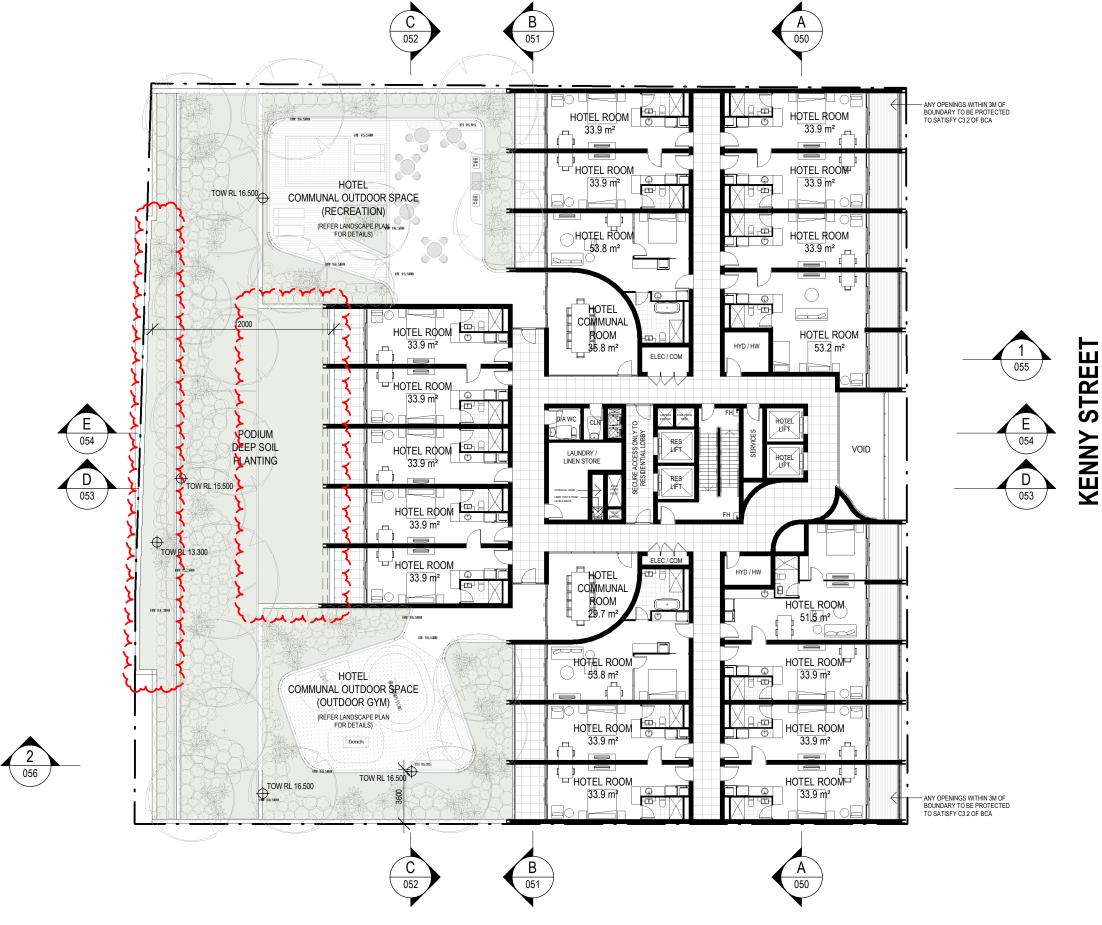

AMENDMENT CLIENT REVIEW 24.06.2022 04.07.2022 19.07.2022 ADDITIONAL INFORMATION ADDITIONAL INFORMATION 18.11.2022 PRELIMINARY cement of any work DESIGN WORKSHOP AUSTRALIA

Wollongong 81a Princes Highway, Fairy Meadow NSW 2519 Tel: (02) 4227 1661 Email: info@designworkshop.com.au Web: www.designworkshop.com.au

Sydney Level 10, 6 Mount Olympus Boulevard, Wolli Creek NSW 2205 Nominated Architect: Robert Gizzi (Reg. 8286)

ANYA SOLUTION Pty Ltd MIXED USE DEVELOPMENT CLIENT: 24-30 KENNY STREET, WOLLONGONG, NSW ADDRESS:

DRAWING NAME: LEVEL 1 PLAN


SCALE BAR: 5 7.5 10 12.5m

ADDITIONAL INFORMATION PROJECT No. ISSUE DATE: 28.11.2022 2289 DRAWN: AK/SL/ML

SCALE: 1:250

Rev.

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All parking and ramps to traffic engineers details. (Subject to Approval)
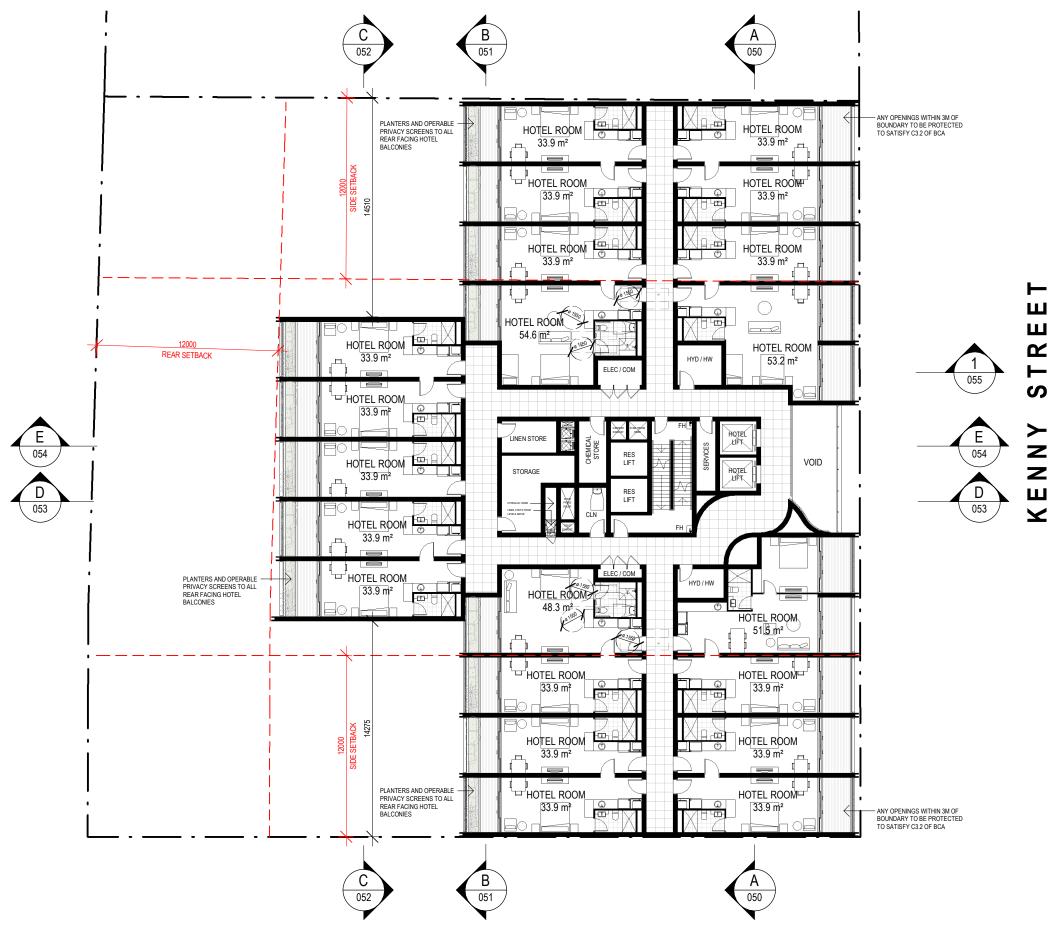
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rk DESIGN WORKSHOP AUSTRALIA

Wollongong 81a Princes Highway, Fairy Meadow NSW 2519 Tel: (02) 4227 1661 Email: info@designworkshop.com.au

Sydney Level 10, 6 Mount Olympus Boulevard, Wolli Creek NSW 2205 Nominated Architect: Web: www.designworkshop.com.au Robert Gizzi (Reg. 8286)

ANYA SOLUTION Pty Ltd MIXED USE DEVELOPMENT CLIENT: 24-30 KENNY STREET, WOLLONGONG, NSW ADDRESS:

DRAWING NAME: LEVEL 2 PLAN

SCALE BAR: 5 7.5 10 12.5m




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Wollongong 81a Princes Highway, Fairy Meadow NSW 2519 Tel: (02) 4227 1661 Email: info@designworkshop.com.au Web: www.designworkshop.com.au


Sydney Level 10, 6 Mount Olympus Boulevard, Wolli Creek NSW 2205 Nominated Architect: Robert Gizzi (Reg. 8286)

ANYA SOLUTION Pty Ltd MIXED USE DEVELOPMENT CLIENT: 24-30 KENNY STREET, WOLLONGONG, NSW ADDRESS:

DRAWING NAME: LEVEL 3 PLAN

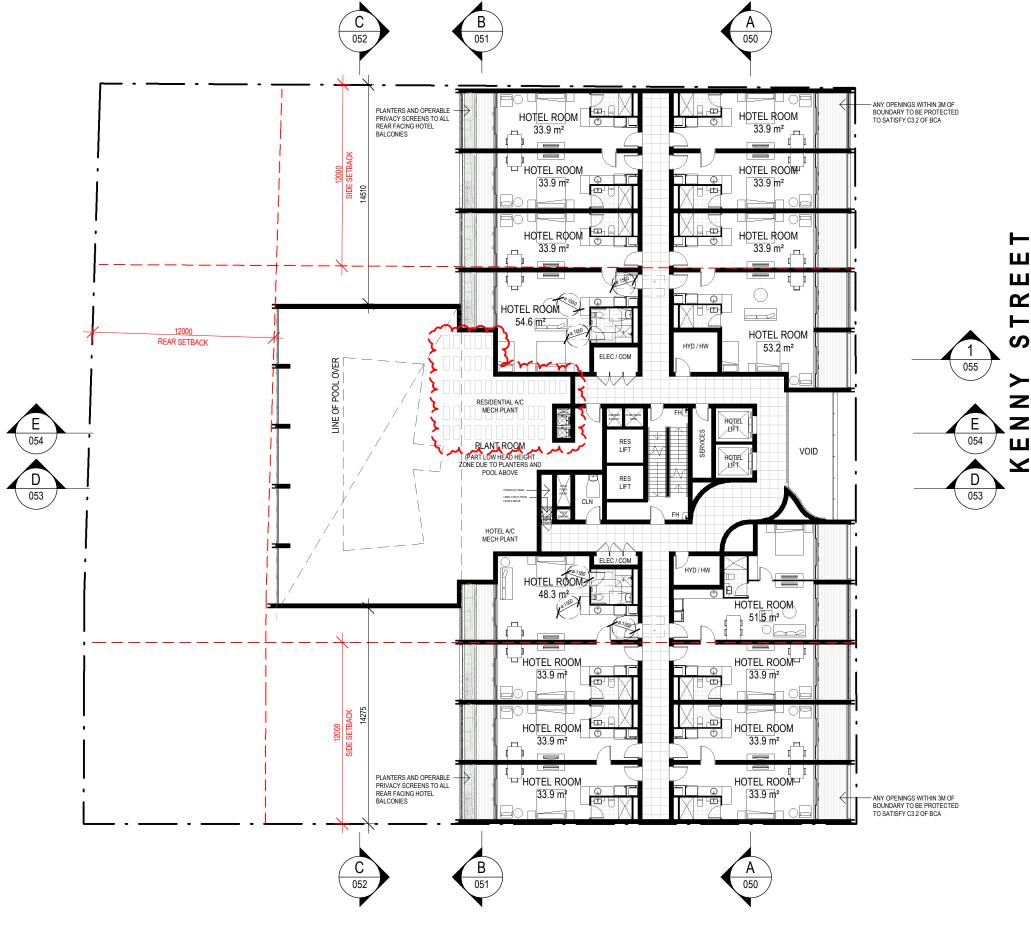SCALE BAR: 5 7.5 10 12.5m

ADDITIONAL INFORMATION ISSUE DATE: PROJECT No. 28.11.2022

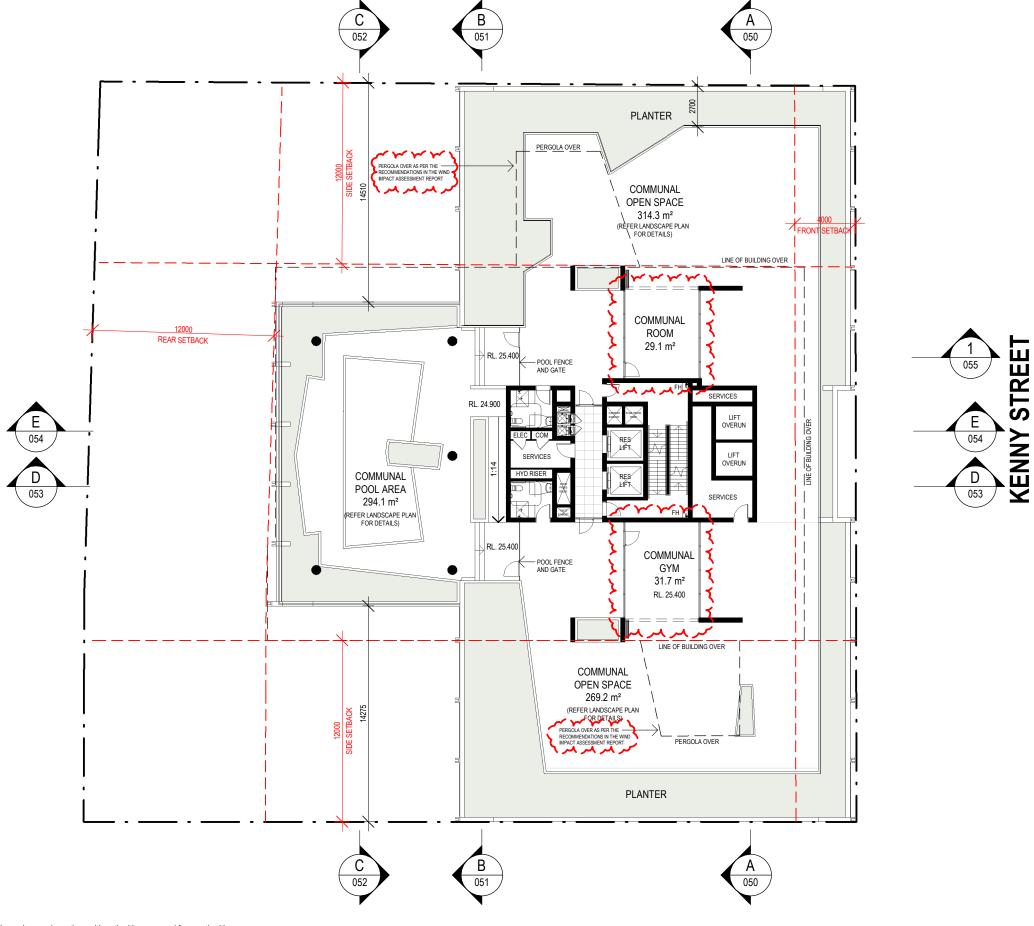

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eters. Verify all dimensions on site prior to commencement of any work.

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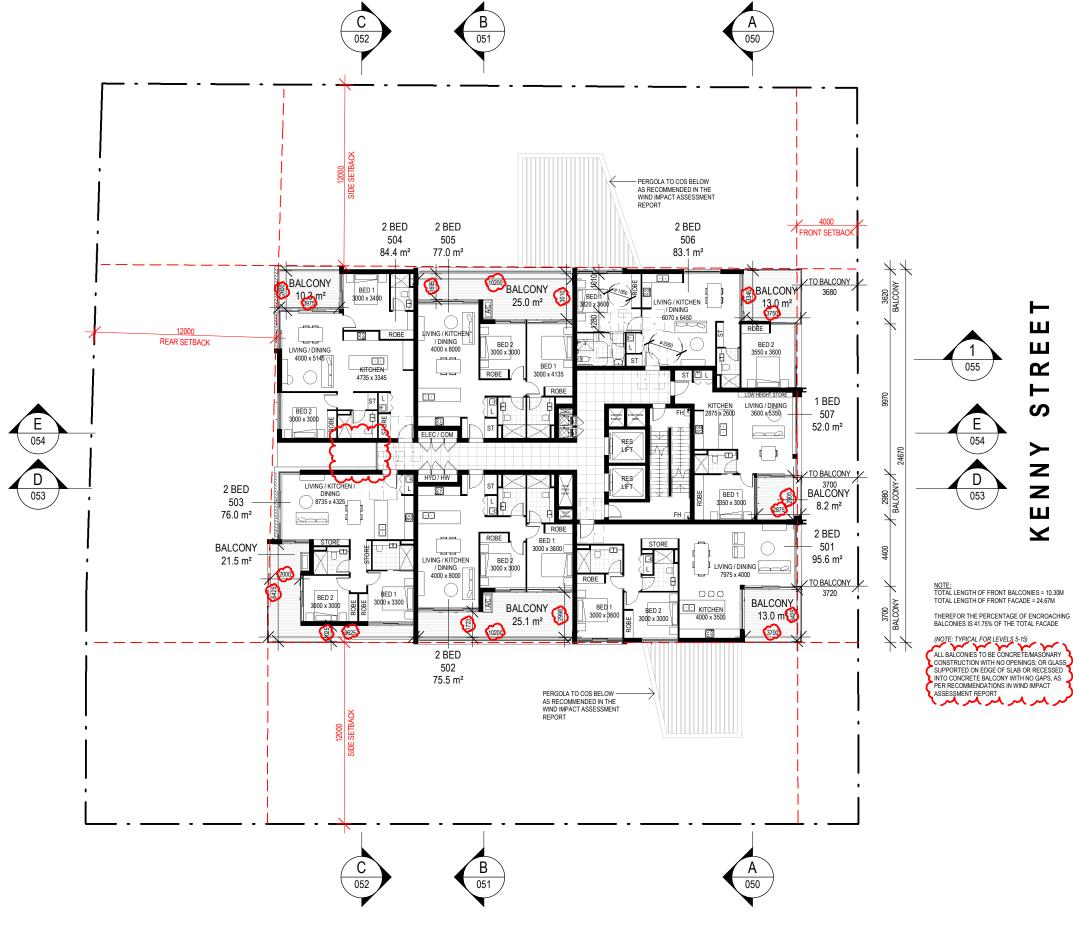
Sydney Level 10, 6 Mount Olympus Boulevard, Wolli Creek NSW 2205 Nominated Architect: Robert Gizzi (Reg. 8286)

CLIENT: ADDRESS: DRAWING NAME: LEVEL 4 PLAN

ANYA SOLUTION Pty Ltd MIXED USE DEVELOPMENT 24-30 KENNY STREET, WOLLONGONG, NSW

SCALE BAR: 5 7.5 10 12.5m

ADDITIONAL INFORMATION ISSUE DATE: PROJECT No.



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All parking and ramps to traffic engineers details, (Subject to Approval)

an parking	and ramps to train	c engineers details. (Subject to App	rovar)
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Wollongong 81a Princes Highway, Fairy Meadow NSW 2519 Tel: (02) 4227 1661 Email: info@designworkshop.com.au

Sydney Level 10, 6 Mount Olympus Boulevard, Wolli Creek NSW 2205 Nominated Architect: Web: www.designworkshop.com.au Robert Gizzi (Reg. 8286)

CLIENT: ADDRESS:


ANYA SOLUTION Pty Ltd MIXED USE DEVELOPMENT 24-30 KENNY STREET, WOLLONGONG, NSW

DRAWING NAME: LEVEL 5 PLAN

ADDITIONAL INFORMATION SCALE BAR: 5 7.5 10 12.5m

PROJECT No. ISSUE DATE: 28.11.2022 2289 DRAWN: AK/SL/ML DWG No. SCALE: 1:250

Rev.

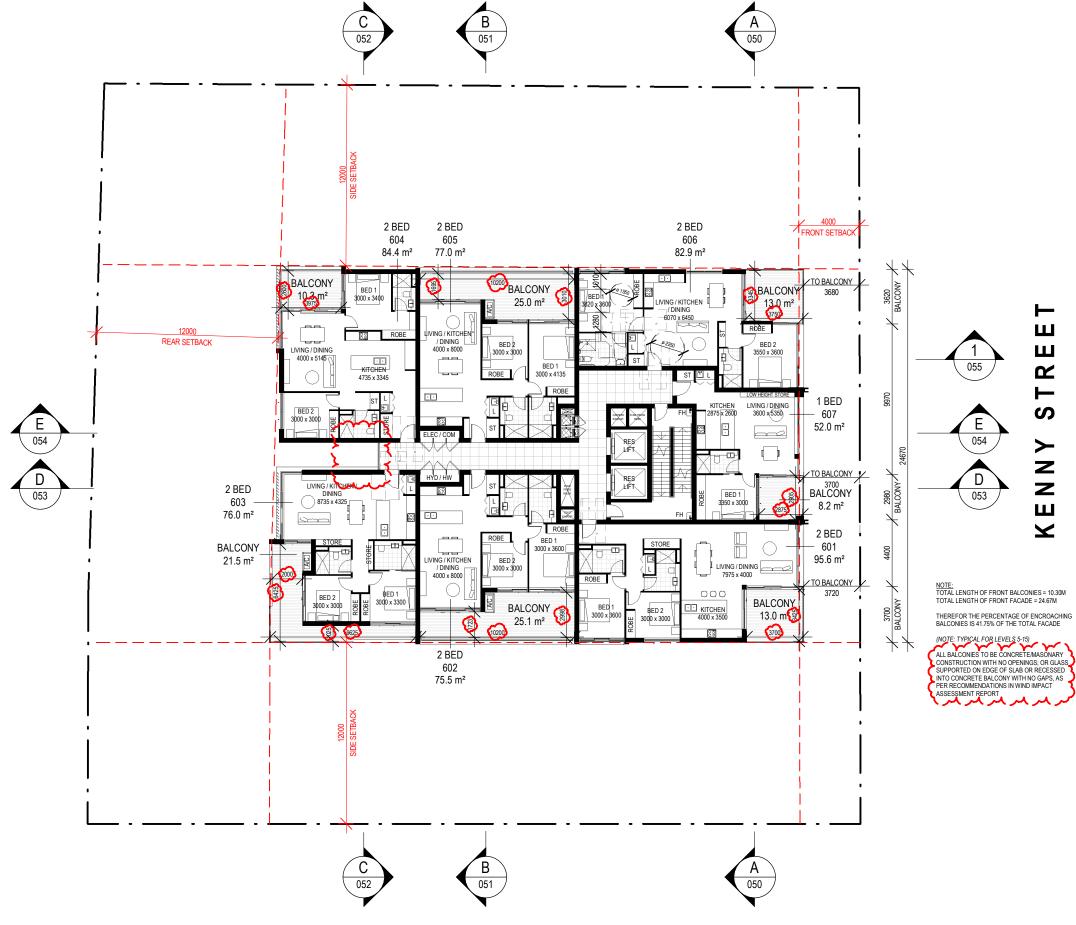

Subject to: full site survey, measurements are preliminary, discussions and meetings with authorities, approval from authorities, relevant consultant information as per council DA requirements. Feasibility completed based on information provided by client. Drawings are not are not suitable for purchase of property.

All parking and ramps to traffic engineers details, (Subject to Approval)

iii parking	and ramps to train	c engineers details. (Subject to Appr	ovai)
REF.	DATE	AMENDMENT	
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Wollongong

81a Princes Highway, Fairy Meadow NSW 2519 Tel: (02) 4227 1661 Email: info@designworkshop.com.au Web: www.designworkshop.com.au

Sydney Level 10, 6 Mount Olympus Boulevard, Wolli Creek NSW 2205 Nominated Architect: Robert Gizzi (Reg. 8286)

ANYA SOLUTION Pty Ltd MIXED USE DEVELOPMENT CLIENT: 24-30 KENNY STREET, WOLLONGONG, NSW ADDRESS: DRAWING NAME: LEVEL 6-13 PLAN (TYPICAL)


ADDITIONAL INFORMATION PROJECT No. ISSUE DATE: 28.11.2022 2289

SCALE BAR:

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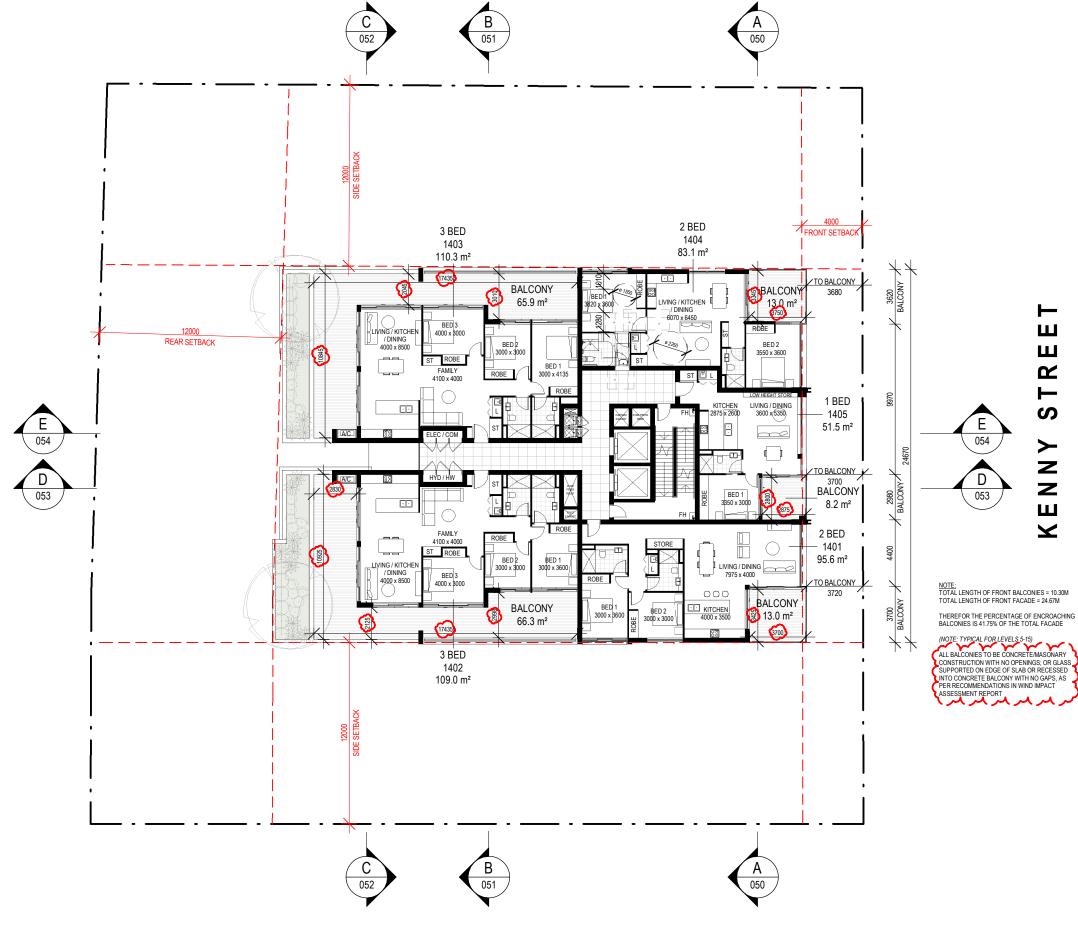
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DWG No.



24.06.2022

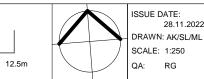AMENDMENT CLIENT REVIEW 04.07.2022 19.07.2022 ADDITIONAL INFORMATION ADDITIONAL INFORMATION 18.11.2022 PRELIMINARY

ncement of any work DESIGN WORKSHOP AUSTRALIA

Wollongong 81a Princes Highway, Fairy Meadow NSW 2519 Tel: (02) 4227 1661 Email: info@designworkshop.com.au

Web: www.designworkshop.com.au

Sydney Level 10, 6 Mount Olympus Boulevard, Wolli Creek NSW 2205 Nominated Architect: Robert Gizzi (Reg. 8286)


CLIENT: ADDRESS:

DRAWING NAME: LEVEL 14 PLAN

ANYA SOLUTION Pty Ltd MIXED USE DEVELOPMENT 24-30 KENNY STREET, WOLLONGONG, NSW

SCALE BAR: 5 7.5 10 12.5m

ADDITIONAL INFORMATION PROJECT No. ISSUE DATE:

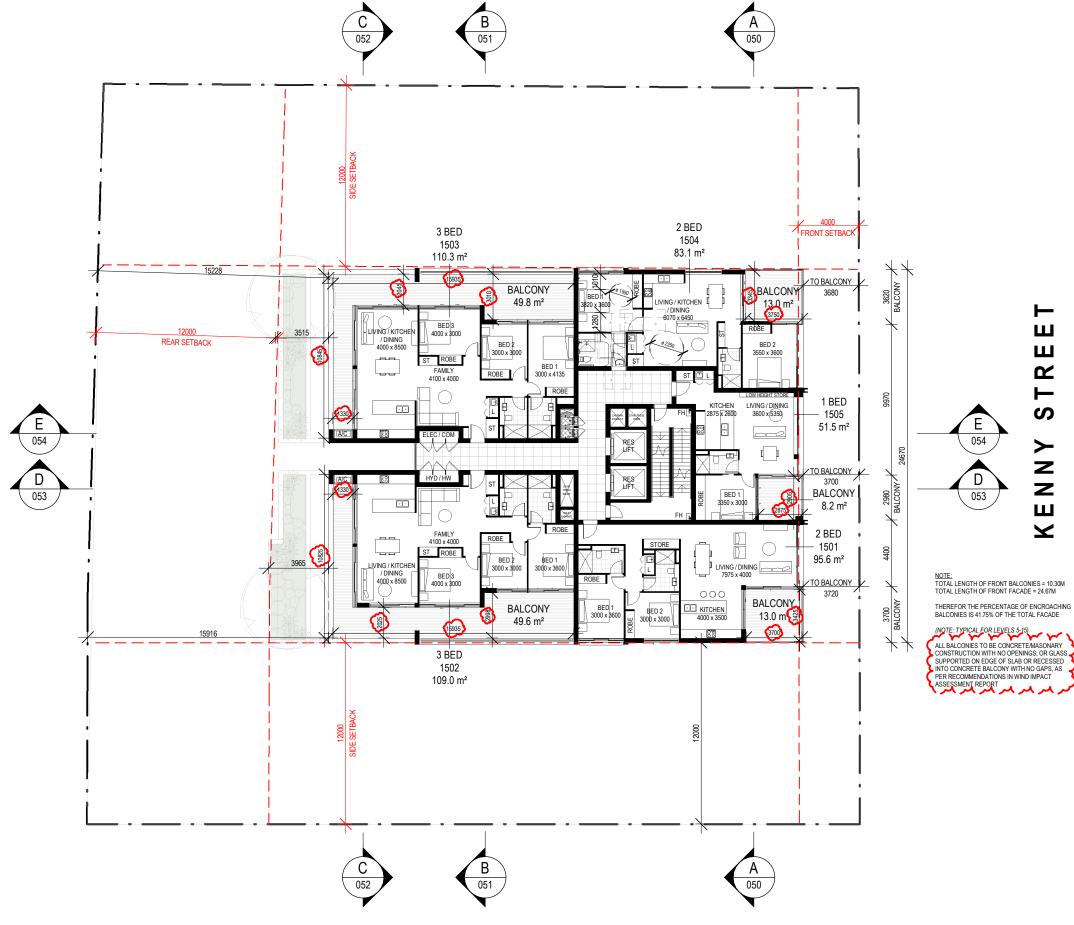

24.06.2022

AMENDMENT CLIENT REVIEW 04.07.2022 19.07.2022 ADDITIONAL INFORMATION ADDITIONAL INFORMATION 18.11.2022 PRELIMINARY cement of any work DESIGN WORKSHOP AUSTRALIA

Wollongong 81a Princes Highway, Tel: (02) 4227 1661


Sydney Level 10, 6 Mount Fairy Meadow NSW 2519 Olympus Boulevard, Wolli Creek NSW 2205 Email: info@designworkshop.com.au Nominated Architect: Web: www.designworkshop.com.au

Robert Gizzi (Reg. 8286) DRAWING NAME: LEVEL 15 PLAN

ANYA SOLUTION Pty Ltd MIXED USE DEVELOPMENT CLIENT: 24-30 KENNY STREET, WOLLONGONG, NSW ADDRESS:

SCALE BAR: 5 7.5 10 12.5m

ADDITIONAL INFORMATION PROJECT No. ISSUE DATE:

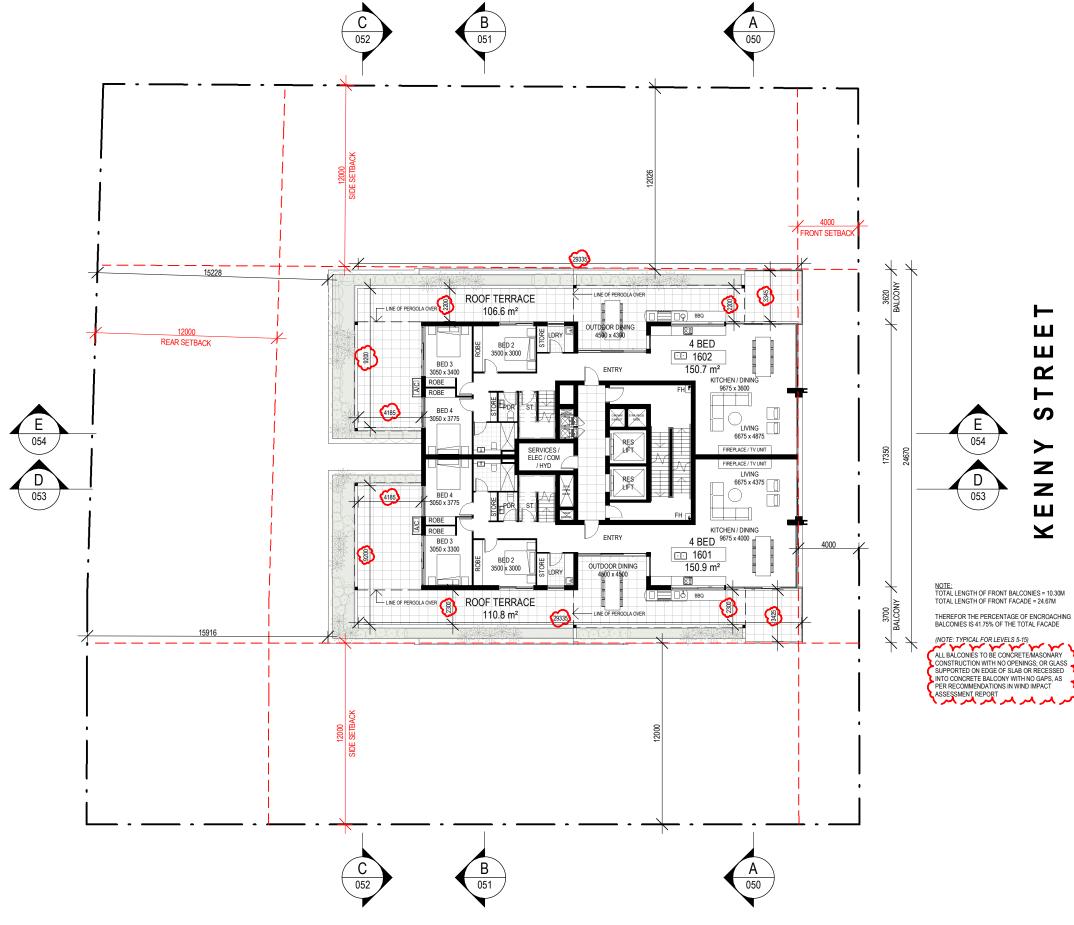

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REF.	DATE	AMENDMENT	
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Sydney Level 10, 6 Mount Olympus Boulevard, Wolli Creek NSW 2205 Nominated Architect: Robert Gizzi (Reg. 8286)

ANYA SOLUTION Pty Ltd MIXED USE DEVELOPMENT CLIENT: 24-30 KENNY STREET, WOLLONGONG, NSW ADDRESS:


DRAWING NAME: LEVEL 16 PLAN

SCALE BAR: 5 7.5 10 12.5m

ADDITIONAL INFORMATION ISSUE DATE: PROJECT No. 28.11.2022 28.11.2022 28.9 DRAWN: AK/SL/ML

SCALE: 1:250

DWG No. Rev. 024 ВВ

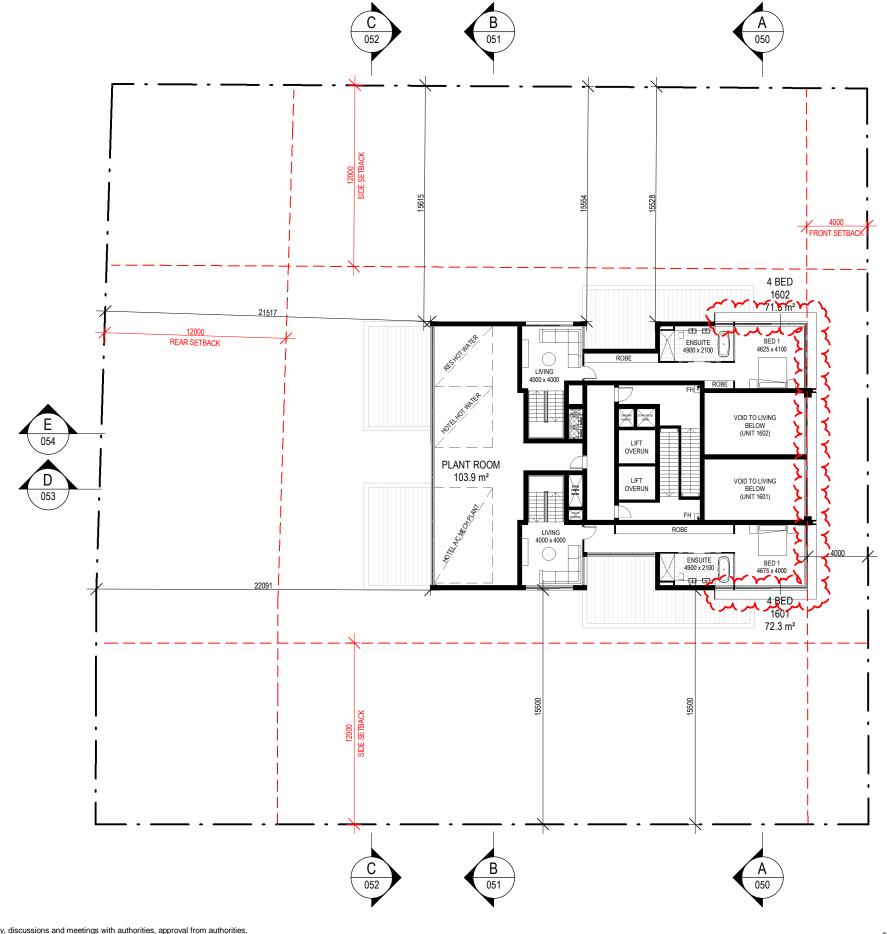

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III parking	and ramps to traffi	c engineers details. (Subject to Appl	roval)		
REF.	DATE	AMENDMENT			
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W	19.07.2022	ADDITIONAL INFORMATION			
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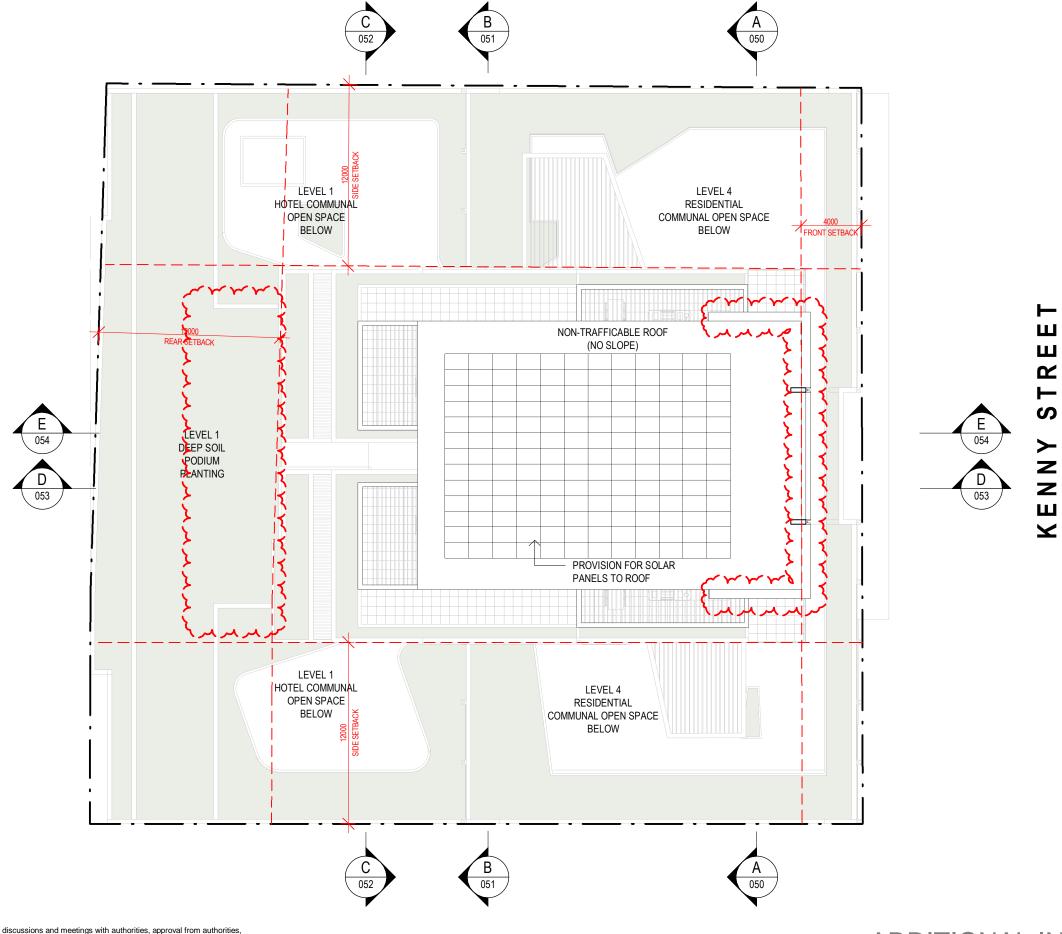
Wollongong 81a Princes Highway, Fairy Meadow NSW 2519 Tel: (02) 4227 1661 Email: info@designworkshop.com.au Web: www.designworkshop.com.au

Sydney Level 10, 6 Mount Olympus Boulevard, Wolli Creek NSW 2205 Nominated Architect: Robert Gizzi (Reg. 8286) DRAWING NAME: LEVEL 17 PLAN

ANYA SOLUTION Pty Ltd MIXED USE DEVELOPMENT CLIENT: 24-30 KENNY STREET, WOLLONGONG, NSW ADDRESS:

SCALE BAR: 5 7.5 10 12.5m





Ali parking	and ramps to train	c engineers details. (Subject to Appr	ovai)
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DISCLAIM All dimensions a	are in millimeters. Verify all o	imensions on site prior to commencement of any work	DESIGN WORKSHOP AUSTRALI

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Sydney Level 10, 6 Mount Olympus Boulevard, Wolli Creek NSW 2205 Nominated Architect: Robert Gizzi (Reg. 8286)

CLIENT: ADDRESS:

DRAWING NAME: ROOF PLAN


ANYA SOLUTION Pty Ltd MIXED USE DEVELOPMENT 24-30 KENNY STREET, WOLLONGONG, NSW

SCALE BAR: 5 7.5 10 12.5m



SCALE: 1:250

ВВ А3

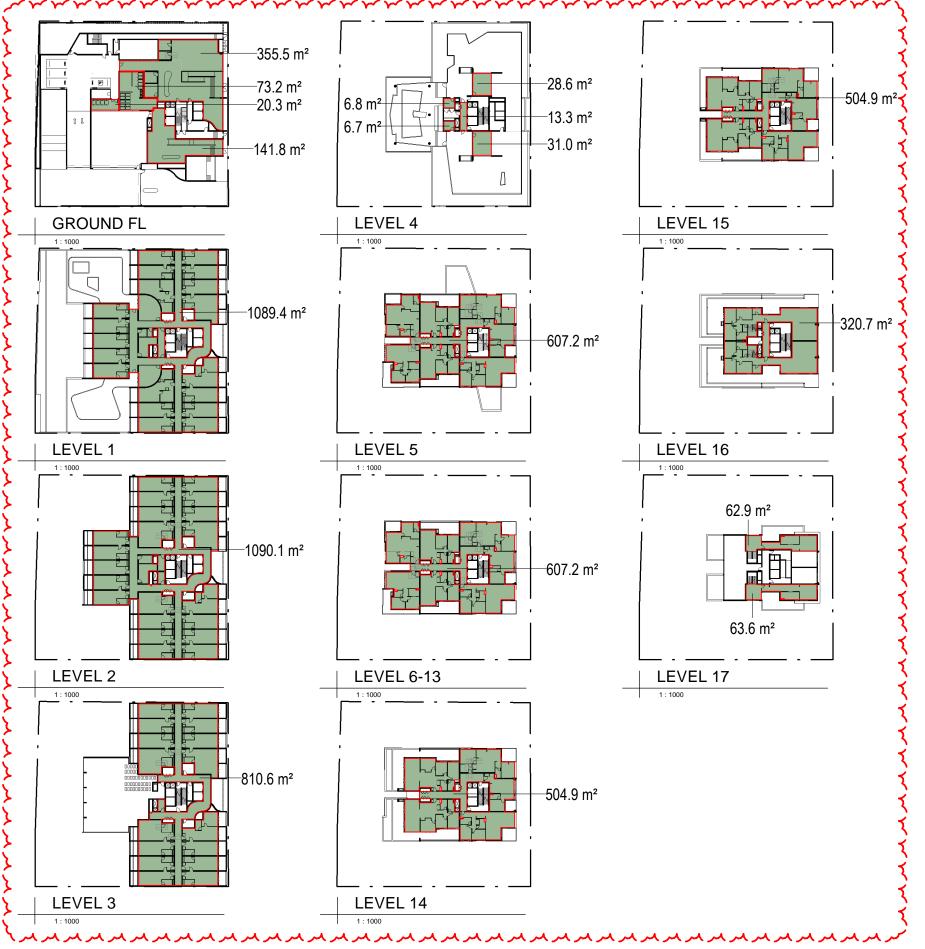

AREA SCHEDULE (GFA)		
LEVEL	AREA	FSR
GROUND FL	590.89 m²	0.24
LEVEL 1	1089.38 m²	0.44
LEVEL 2	1090.06 m ²	0.44
LEVEL 3	810.57 m ²	0.33
LEVEL 4	86.42 m²	0.04
LEVEL 5	607.20 m ²	0.25
LEVEL 6	607.20 m ²	0.25
LEVEL 7	607.20 m ²	0.25
LEVEL 8	607.20 m ²	0.25
LEVEL 9	607.20 m ²	0.25
LEVEL 10	607.20 m ²	0.25
LEVEL 11	607.20 m ²	0.25
LEVEL 12	607.20 m ²	0.25
LEVEL 13	607.20 m ²	0.25
LEVEL 14	504.92 m²	0.20
LEVEL 15	504.92 m²	0.20
LEVEL 16	320.68 m²	0.13
LEVEL 17	126.46 m²	0.05
	10589.12 m²	4.29

LEVEL	AREA	FSR
COMMERCIAL		
GROUND FL	375.86 m ²	0.15
LEVEL 1	1089.38 m²	0.44
LEVEL 2	1090.06 m ²	0.44
LEVEL 3	810.57 m ²	0.33
	3365.88 m²	1.36
RESIDENTIAL		
GROUND FL	215.02 m ²	0.09
LEVEL 4	86.42 m²	0.04
LEVEL 5	607.20 m ²	0.25
LEVEL 6	607.20 m ²	0.25
LEVEL 7	607.20 m ²	0.25
LEVEL 8	607.20 m ²	0.25
LEVEL 9	607.20 m ²	0.25
LEVEL 10	607.20 m ²	0.25
LEVEL 11	607.20 m ²	0.25
LEVEL 12	607.20 m ²	0.25
LEVEL 13	607.20 m ²	0.25
LEVEL 14	504.92 m ²	0.20
LEVEL 15	504.92 m ²	0.20
LEVEL 16	320.68 m ²	0.13
LEVEL 17	126.46 m ²	0.05
	7223.25 m ²	2.93
	10589.12 m ²	4.29
e Area	2466	
	Area % 5.88 31.79	Total Area 10589.13
	3.25 68.21	10369.13
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oposed FSR	4.29 :1	
ea Difference	1.5	

REF.	DATE	AMENDMENT	
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Web: www.designworkshop.com.au

Wollongong 81a Princes Highway, Fairy Meadow NSW 2519 Tel: (02) 4227 1661

Email: info@designworkshop.com.au

Sydney Level 10, 6 Mount Olympus Boulevard, Wolli Creek NSW 2205 Nominated Architect: Robert Gizzi (Reg. 8286)


CLIENT:

ANYA SOLUTION Pty Ltd MIXED USE DEVELOPMENT 24-30 KENNY STREET, WOLLONGONG, NSW

DRAWING NAME: GFA PLANS

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	SCALE:	. IVIL	DWG No.	Rev.
	QA·	RG	027	BF

ADDITIONAL INFORMATION

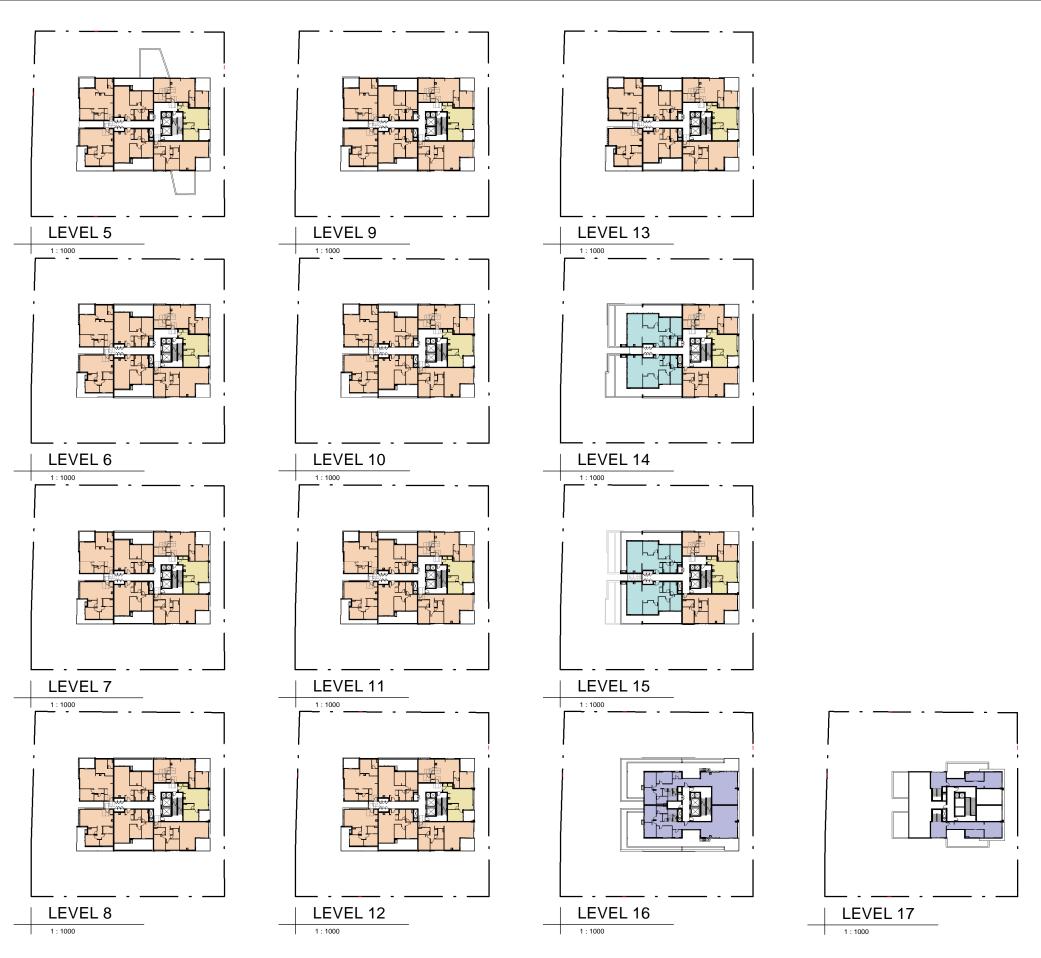

ROOM SCHEDULE			
UNIT#	UNIT TYPE	AREA	

LEVEL 5		
507	1 BED	52.0 m ²
501	2 BED	95.6 m²
503	2 BED	76.0 m ²
505	2 BED	77.0 m²
504	2 BED	84.4 m²
502	2 BED	75.5 m²
506	2 BED	83.1 m²
	•	E 42 7 mg2

		543.7 m ²
LEVEL 6		
607	1 BED	52.0 m ²
601	2 BED	95.6 m²
603	2 BED	76.0 m²
605	2 BED	77.0 m²
604	2 BED	84.4 m²
602	2 BED	75.5 m²
606	2 BED	82.9 m²
		543.5 m ²

		J4J.J III
LEVEL 7		
707	1 BED	52.0 m ²
701	2 BED	95.6 m ²
703	2 BED	76.0 m ²
705	2 BED	77.0 m ²
704	2 BED	84.4 m²
702	2 BED	75.5 m²
706	2 BED	83.1 m ²
		543.7 m²

LEVEL 8		
807	1 BED	52.0 m ²
801	2 BED	95.6 m²
803	2 BED	76.0 m ²
805	2 BED	77.0 m²
804	2 BED	84.4 m²
802	2 BED	75.5 m²
806	2 BED	83.1 m ²
		543.7 m ²

LEVEL 9		
907	1 BED	52.0 m ²
901	2 BED	95.6 m ²
903	2 BED	76.0 m ²
905	2 BED	77.0 m²
904	2 BED	84.4 m²
902	2 BED	75.5 m²
906	2 BED	83.1 m ²
		543.7 m²

		543.7 Mf
LEVEL 10		
1007	1 BED	52.0 m ²
1001	2 BED	95.6 m ²
1003	2 BED	76.0 m ²
1005	2 BED	77.0 m ²
1004	2 BED	84.4 m²
1002	2 BED	75.5 m²
1006	2 BED	83.1 m ²
		543.7 m²

TOTAL

1 BED

2 BED 3 BED

4 BED

ROOM SCHEDULE UNIT # UNIT TYPE AREA

1107	1 BED	52.0 m ²
1101	2 BED	95.6 m²
1103	2 BED	76.0 m ²
1105	2 BED	77.0 m ²
1104	2 BED	84.4 m²
1102	2 BED	75.5 m ²
1106	2 BED	83.1 m ²
	•	543.7 m ²

VEL 12		
07	1 BED	52.0 m²
01	2 BED	95.6 m²
03	2 BED	76.0 m ²
05	2 BED	77.0 m²
04	2 BED	84.4 m²
02	2 BED	75.5 m²
06	2 BED	83.1 m²
		543.7 m ²

EVEL 13		
307	1 BED	52.0 m²
301	2 BED	95.6 m²
303	2 BED	76.0 m²
305	2 BED	77.0 m²
304	2 BED	84.4 m²
302	2 BED	75.5 m²
306	2 BED	83.1 m²
		543.7 m²

LEVEL 14		
1405	1 BED	51.5 m²
1401	2 BED	95.6 m ²
1404	2 BED	83.1 m²
1403	3 BED	110.3 m ²
1402	3 BED	109.0 m²
		449 4 m ²

LEVEL 15		
1505	1 BED	51.5 m ²
1501	2 BED	95.6 m ²
1504	2 BED	83.1 m ²
1503	3 BED	110.3 m ²
1502	3 BED	109.0 m ²
		449.5 m ²

LEVEL 16		
1601	4 BED	150.9 m ²
1602	4 BED	150.7 m ²
		301.5 m ²

LEVEL 17		
1602	4 BED	71.5 m²
1601	4 BED	72.3 m ²
		143.9 m²

6237.3 m²

UNIT TYPE SCHEDULE NO OF ROOMS TYPES 1 BED 2 BED 58 3 BED 4 BED

75

DISCLAIMER
Subject to: full site survey, measurements are preliminary, discussions and meetings with authorities, approval from authorities, relevant consultant information as per council DA requirements. Feasibility completed based on information provided by client.

Drawings are not are not suitable for purchase of property.

All parking and ramps to traffic engineers details. (Subject to Approval)

AMENDMENT
DA SUBMISSION
CLIENT ISSUE
CLIENT REVIEW 02.12.2021 27.04.2022 24.06.2022 ADDITIONAL INFORMATION 04.07.2022

DESIGN WORKSHOP AUSTRALIA

Wollongong 81a Princes Highway, Fairy Meadow NSW 2519 Tel: (02) 4227 1661 Email: info@designworkshop.com.au

Web: www.designworkshop.com.au


Sydney Level 10, 6 Mount Olympus Boulevard, Wolli Creek NSW 2205 Nominated Architect: Robert Gizzi (Reg. 8286)

CLIENT: ADDRESS:

DRAWING NAME: UNIT KEY PLAN

ANYA SOLUTION Pty Ltd MIXED USE DEVELOPMENT 24-30 KENNY STREET, WOLLONGONG, NSW

ADDITIONAL INFORMATION

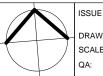

7	ISSUE DATE: 28.11.2022 DRAWN: ML	PROJECT No. 2289			
Ţ	SCALE:	DWG No. Rev.			
	QA: RG	028 BE			

	TYPE	D	W	Н	V
501					
2 BED					
BASEMENT 1	STORE (BASEMENT)	900		2400	5.40
LEVEL 5	STORE (INTERNAL)	650	2400	2700	4.21
502					9.61
2 BED					
BASEMENT 1	STORE (BASEMENT)	900	2500	2400	5.40
LEVEL 5	STORE (INTERNAL)	800		2700	2.81
LEVEL 5	STORE (INTERNAL)	350	1300	2700	1.23 9.44
503					5.77
2 BED					
BASEMENT 1	STORE (BASEMENT)			2400	5.40
LEVEL 5 LEVEL 5	STORE (INTERNAL)	300 400		2700 2700	1.54 2.52
LEVEL 3	310KE (INTERNAL)	400	2333	2700	9.46
504					
2 BED					
BASEMENT 1	STORE (BASEMENT)	_		2400	5.40
LEVEL 5 LEVEL 5	STORE (INTERNAL)	600 800		2700 2700	1.78 3.46
, , ,	STORE (NATERIAL)	1000	1000	12,00	10.6
505					
2 BED BASEMENT 1	STORE (BASEMENT)	900	2500	2400	5.40
LEVEL 5	STORE (BASEMENT)	800		2700	2.81
LEVEL 5	STORE (INTERNAL)	350	1300	2700	1.23
					9.44
506					
2 BED BASEMENT 1	STORE (BASEMENT)	ann	2500	2400	5.40
LEVEL 5	STORE (INTERNAL)	1050	750	2700	2.13
LEVEL 5	STORE (INTERNAL)	450	1600	2700	1.94
					9.47
507 1 BED					
BASEMENT 2	STORE (BASEMENT)	600	2500	2400	3.60
		650	1125	2700	1.97
LEVEL 5	STORE (INTERNAL)	000			
	STORE (INTERNAL)	300	3600	1000	
LEVEL 5		_	-	1000	
LEVEL 5 601		_	-	1000	
601 2 BED		300	3600	1000	6.65
601 2 BED BASEMENT 2	STORE (INTERNAL)	300	3600		5.70 4.21
LEVEL 5 601 2 BED BASEMENT 2 LEVEL 6	STORE (INTERNAL) STORE (BASEMENT)	300 950	3600 2500	2400	5.70 4.21
LEVEL 5 601 2 BED BASEMENT 2 LEVEL 6 602	STORE (INTERNAL) STORE (BASEMENT)	300 950	3600 2500	2400	5.70 4.21
LEVEL 5 601 2 BED BASEMENT 2 LEVEL 6 602 2 BED	STORE (INTERNAL) STORE (BASEMENT)	950 650	3600 2500 2400	2400	5.70 4.21 9.91
LEVEL 5 LEVEL 5 601 2 BED BASEMENT 2 LEVEL 6 602 2 BED BASEMENT 2 LEVEL 6 LEVEL 6 LEVEL 6 LEVEL 6 LEVEL 6	STORE (INTERNAL) STORE (BASEMENT) STORE (INTERNAL) STORE (BASEMENT) STORE (INTERNAL)	950 650 900 800	2500 2400 2500 1300	2400 2700 2400 2700	5.70 4.21 9.91 5.40 2.81
LEVEL 5 601 2 BED BASEMENT 2 LEVEL 6 602 2 BED BASEMENT 2 BASEMENT 2	STORE (INTERNAL) STORE (BASEMENT) STORE (INTERNAL) STORE (BASEMENT)	950 650 900	2500 2400 2500 1300	2400 2700 2400	5.70 4.21 9.91 5.40 2.81 1.23
LEVEL 5 601 2 BED BASEMENT 2 LEVEL 6 602 2 BED BASEMENT 2 LEVEL 6 LEVEL 6 LEVEL 6	STORE (INTERNAL) STORE (BASEMENT) STORE (INTERNAL) STORE (BASEMENT) STORE (INTERNAL)	950 650 900 800	2500 2400 2500 1300	2400 2700 2400 2700	5.70 4.21 9.91 5.40 2.81 1.23
LEVEL 5 601 2 BED BASEMENT 2 LEVEL 6 602 2 BED BASEMENT 2 LEVEL 6 LEVEL 6 LEVEL 6 603 2 BED	STORE (INTERNAL) STORE (BASEMENT) STORE (INTERNAL) STORE (BASEMENT) STORE (INTERNAL)	950 650 900 800	2500 2400 2500 1300	2400 2700 2400 2700 2700	5.70 4.21 9.91 5.40 2.81 1.23
LEVEL 5 601 2 BED BASEMENT 2 LEVEL 6 602 2 BED BASEMENT 2 LEVEL 6 LEVEL 6 LEVEL 6 603 2 BED BASEMENT 2	STORE (INTERNAL) STORE (BASEMENT) STORE (INTERNAL) STORE (INTERNAL) STORE (INTERNAL) STORE (INTERNAL)	950 650 900 800 350	2500 2400 2500 1300 1300 2500	2400 2700 2400 2700 2700 2700	5.70 4.21 9.91 5.40 2.81 1.23 9.44
LEVEL 5 601 2 BED BASEMENT 2 LEVEL 6 602 2 BED BASEMENT 2 LEVEL 6 LEVEL 6 603 2 BED BASEMENT 2 LEVEL 6 LEVEL 6 603 2 BED BASEMENT 2 LEVEL 6 BASEMENT 2 LEVEL 6	STORE (INTERNAL) STORE (BASEMENT) STORE (INTERNAL) STORE (INTERNAL) STORE (INTERNAL) STORE (INTERNAL) STORE (BASEMENT) STORE (BASEMENT) STORE (INTERNAL)	950 650 900 800 350	2500 2400 2500 1300 1300 2500 1900	2400 2700 2400 2700 2700 2700 2400 2700	5.70 4.21 9.91 5.40 2.81 1.23 9.44
LEVEL 5 601 2 BED BASEMENT 2 LEVEL 6 602 2 BED BASEMENT 2 LEVEL 6 LEVEL 6 603 2 BED BASEMENT 2 LEVEL 6 LEVEL 6 603 2 BED BASEMENT 2 LEVEL 6 LEVEL 6	STORE (INTERNAL) STORE (BASEMENT) STORE (INTERNAL) STORE (INTERNAL) STORE (INTERNAL) STORE (INTERNAL)	950 650 900 800 350	2500 2400 2500 1300 1300 2500 1900	2400 2700 2400 2700 2700 2700	5.40 5.40 2.81 1.23 9.44 5.40 1.54 2.52
LEVEL 5 601 2 BED BASEMENT 2 LEVEL 6 602 2 BED BASEMENT 2 LEVEL 6 LEVEL 6 603 2 BED BASEMENT 2 LEVEL 6 LEVEL 6 604 405 405 405 405 405 405 405 405 405 4	STORE (INTERNAL) STORE (BASEMENT) STORE (INTERNAL) STORE (INTERNAL) STORE (INTERNAL) STORE (INTERNAL) STORE (BASEMENT) STORE (BASEMENT) STORE (INTERNAL)	950 650 900 800 350	2500 2400 2500 1300 1300 2500 1900	2400 2700 2400 2700 2700 2700 2400 2700	5.40 5.40 2.81 1.23 9.44 5.40 1.54 2.52
LEVEL 5 601 2 BED BASEMENT 2 LEVEL 6 602 2 BED BASEMENT 2 LEVEL 6 LEVEL 6 603 2 BED BASEMENT 2 LEVEL 6 603 2 BED BASEMENT 2 LEVEL 6 604 2 BED	STORE (INTERNAL) STORE (BASEMENT) STORE (INTERNAL) STORE (INTERNAL) STORE (INTERNAL) STORE (INTERNAL) STORE (BASEMENT) STORE (INTERNAL) STORE (INTERNAL)	950 650 900 800 350 900 400	2500 2400 2400 1300 1300 2500 1900 2335	2400 2700 2400 2700 2700 2400 2700 2700	5.40 5.40 2.81 1.23 9.44 5.40 1.54 2.52 9.46
LEVEL 5 601 2 BED BASEMENT 2 LEVEL 6 602 2 BED BASEMENT 2 LEVEL 6 LEVEL 6 603 2 BED BASEMENT 2 LEVEL 6 604 2 BED BASEMENT 2	STORE (INTERNAL) STORE (BASEMENT) STORE (INTERNAL)	950 650 900 800 350 900 400	2500 2400 2400 1300 1300 2500 1900 2335	2400 2700 2400 2700 2700 2700 2700 2700	5.40 5.40 2.81 1.23 9.44 5.40 1.54 2.52 9.46
LEVEL 5 601 2 BED BASEMENT 2 LEVEL 6 602 2 BED BASEMENT 2 LEVEL 6 LEVEL 6 603 2 BED BASEMENT 2 LEVEL 6 604 2 BED BASEMENT 2 LEVEL 6 604 2 BED BASEMENT 2 LEVEL 6	STORE (INTERNAL) STORE (BASEMENT) STORE (INTERNAL)	950 650 900 800 350 900 400	2500 2400 2500 1300 1300 2500 1900 2335	2400 2700 2400 2700 2700 2400 2700 2700	5.40 5.40 2.81 1.23 9.44 5.40 4.54 1.54 2.52 9.46
LEVEL 5 601 2 BED BASEMENT 2 LEVEL 6 602 2 BED BASEMENT 2 LEVEL 6 LEVEL 6 603 2 BED BASEMENT 2 LEVEL 6 604 2 BED BASEMENT 2 LEVEL 6 604 2 BED BASEMENT 2 LEVEL 6	STORE (INTERNAL) STORE (BASEMENT) STORE (INTERNAL)	950 650 900 800 350 900 400	2500 2400 2500 1300 1300 2500 1900 2335	2400 2700 2400 2700 2700 2700 2700 2700	5.40 5.40 2.81 1.23 9.44 5.40 4.54 1.54 2.52 9.46 4.54 1.78 3.46
LEVEL 5 601 2 BED BASEMENT 2 LEVEL 6 602 2 BED BASEMENT 2 LEVEL 6 LEVEL 6 603 2 BED BASEMENT 2 LEVEL 6 604 2 BED BASEMENT 2 LEVEL 6 604 2 BED BASEMENT 2 LEVEL 6 604 605	STORE (INTERNAL) STORE (BASEMENT) STORE (INTERNAL)	950 650 900 800 350 900 400	2500 2400 2500 1300 1300 2500 1900 2335	2400 2700 2400 2700 2700 2700 2700 2700	5.40 5.40 2.81 1.23 9.44 5.40 4.54 1.54 2.52 9.46 4.54 1.78 3.46
LEVEL 5 601 2 BED BASEMENT 2 LEVEL 6 602 2 BED BASEMENT 2 LEVEL 6 LEVEL 6 603 2 BED BASEMENT 2 LEVEL 6 LEVEL 6 604 2 BED BASEMENT 2 LEVEL 6 604 2 BED BASEMENT 2 LEVEL 6 605 2 BED	STORE (INTERNAL) STORE (BASEMENT) STORE (INTERNAL)	950 650 900 800 350 900 400 1800 600 800	2500 2400 2400 2500 1300 1300 2500 1900 2335 1050 1100 1600	2400 2700 2700 2700 2700 2700 2700 2700	5.40 2.81 1.23 9.44 5.40 1.54 2.52 9.46 4.54 1.78 3.46 9.77
LEVEL 5 601 2 BED BASEMENT 2 LEVEL 6 602 2 BED BASEMENT 2 LEVEL 6 LEVEL 6 603 2 BED BASEMENT 2 LEVEL 6 604 2 BED BASEMENT 2 LEVEL 6 604 2 BED BASEMENT 2 LEVEL 6 605 2 BED BASEMENT 2	STORE (INTERNAL) STORE (BASEMENT) STORE (INTERNAL)	950 650 900 800 350 900 400 1800 600 800	2500 2400 2500 1300 1300 2500 1900 2335 1050 1100 1600	2400 2700 2700 2700 2700 2700 2700 2700	5.40 2.81 1.23 9.44 5.40 1.54 2.52 9.46 4.54 1.78 3.46 9.77
LEVEL 5 601 2 BED BASEMENT 2 LEVEL 6 602 2 BED BASEMENT 2 LEVEL 6 603 2 BED BASEMENT 2 LEVEL 6 604 2 BED BASEMENT 2 LEVEL 6 604 2 BED BASEMENT 2 LEVEL 6 604 2 BED BASEMENT 2 LEVEL 6 606 605 2 BED BASEMENT 2 LEVEL 6	STORE (INTERNAL) STORE (BASEMENT) STORE (INTERNAL)	950 650 900 800 350 900 400 1800 600 800	2500 2400 2500 1300 1300 2500 1900 2335 1050 1100 1600	2400 2700 2700 2700 2700 2700 2700 2700	5.40 2.81 1.23 9.44 5.40 1.54 2.52 9.46 4.54 1.78 3.46 9.77
LEVEL 5 601 2 BED BASEMENT 2 LEVEL 6 602 2 BED BASEMENT 2 LEVEL 6 LEVEL 6 603 2 BED BASEMENT 2 LEVEL 6 604 2 BED BASEMENT 2 LEVEL 6 604 2 BED BASEMENT 2 LEVEL 6	STORE (INTERNAL) STORE (BASEMENT) STORE (INTERNAL) STORE (BASEMENT) STORE (INTERNAL)	950 650 900 800 350 900 400 1800 800	2500 2400 2500 1300 1300 2500 1900 2335 1050 1100 1600	2400 2700 2700 2700 2700 2700 2700 2700	5.40 2.81 1.23 9.44 5.40 1.54 2.52 9.46 4.54 1.78 3.46 9.77
LEVEL 5 601 2 BED BASEMENT 2 LEVEL 6 602 2 BED BASEMENT 2 LEVEL 6 LEVEL 6 603 2 BED BASEMENT 2 LEVEL 6 LEVEL 6 604 2 BED BASEMENT 2 LEVEL 6 605 2 BED BASEMENT 2 LEVEL 6 605 2 BED BASEMENT 2 LEVEL 6 606 606	STORE (INTERNAL) STORE (BASEMENT) STORE (INTERNAL) STORE (BASEMENT) STORE (INTERNAL)	950 650 900 800 350 900 400 1800 800	2500 2400 2500 1300 1300 2500 1900 2335 1050 1100 1600	2400 2700 2700 2700 2700 2700 2700 2700	5.40 2.81 1.23 9.44 5.40 1.54 2.52 9.46 4.54 1.78 3.46 9.77
LEVEL 5 601 2 BED BASEMENT 2 LEVEL 6 602 2 BED BASEMENT 2 LEVEL 6 LEVEL 6 603 2 BED BASEMENT 2 LEVEL 6 604 2 BED BASEMENT 2 LEVEL 6 604 2 BED BASEMENT 2 LEVEL 6 605 2 BED BASEMENT 2 LEVEL 6 605 2 BED BASEMENT 2 LEVEL 6 606 605 2 BED BASEMENT 2 LEVEL 6 606 606 606 606 2 BED	STORE (INTERNAL) STORE (BASEMENT) STORE (INTERNAL)	950 650 900 800 350 900 400 1800 800 1200 800 350	2500 2400 2400 2500 1300 1300 2500 1900 2335 1050 1100 1600	2400 2700 2700 2700 2700 2700 2700 2700	5.40 2.81 1.23 9.44 5.40 2.52 9.46 4.54 1.78 3.46 9.77
LEVEL 5 601 2 BED BASEMENT 2 LEVEL 6 602 2 BED BASEMENT 2 LEVEL 6 LEVEL 6 603 2 BED BASEMENT 2 LEVEL 6 LEVEL 6 604 2 BED BASEMENT 2 LEVEL 6 605 2 BED BASEMENT 2 LEVEL 6 605 2 BED BASEMENT 2 LEVEL 6 606 606	STORE (INTERNAL) STORE (BASEMENT) STORE (INTERNAL) STORE (BASEMENT) STORE (INTERNAL)	950 650 900 800 350 900 400 1800 800 1200 800 350	2500 2400 2400 2500 1300 1300 2500 1900 2335 1050 1100 1600	2400 2700 2700 2700 2700 2700 2700 2700	5.40 5.40 2.81 1.23 9.44 5.40 1.54 2.52 9.46 4.54 1.78 3.46 9.77 4.03 2.81 1.23 8.07
LEVEL 5 601 2 BED BASEMENT 2 LEVEL 6 602 2 BED BASEMENT 2 LEVEL 6 603 2 BED BASEMENT 2 LEVEL 6 604 2 BED BASEMENT 2 LEVEL 6 604 2 BED BASEMENT 2 LEVEL 6 LEVEL 6 606 2 BED BASEMENT 2 LEVEL 6 606 2 BED BASEMENT 2 LEVEL 6 606 2 BED BASEMENT 2 LEVEL 6 607 808	STORE (INTERNAL) STORE (BASEMENT) STORE (INTERNAL) STORE (BASEMENT) STORE (INTERNAL) STORE (INTERNAL)	950 650 900 800 350 900 400 1200 800 350	2500 2400 2400 2500 1300 1300 2500 1050 1100 1400 1300 1300	2400 2700 2700 2700 2700 2700 2700 2700	5.40 5.40 5.40 1.23 9.44 5.40 1.54 2.52 9.46 4.54 1.78 3.46 9.77 4.03 2.81 1.23 8.07

STORAGE SCHEDULE

	STORAGE SCHEDULE	STORAGE SCHEDULE				
	TYPE D W H VOL		TYPE [o W	Н	V
		806				
D		2 BED				
EMENT 2	STORE (BASEMENT) 900 2500 2400 5.40 m³	BASEMENT 2	STORE (BASEMENT) 900			
EL 6	STORE (INTERNAL) 650 1125 2700 1.97 m³	LEVEL 8	STORE (INTERNAL) 10		2700	2.13
EL 6	STORE (INTERNAL) 300 3600 1000 1.08 m³	LEVEL 8	STORE (INTERNAL) 450	0 1600	2700	1.94
	8.45 m³	807				9.47
ED		1 BED				T
EMENT 2	STORE (BASEMENT) 950 2500 2400 5.70 m ³	BASEMENT 2	STORE (BASEMENT) 600			3.60
EL 7	STORE (INTERNAL) 650 2400 2700 4.21 m³	LEVEL 8	STORE (INTERNAL) 650		_	1.97
	9.91 m³	LEVEL 8	STORE (INTERNAL) 300	3 3600	1000	
:D		901				6.6
EMENT 2	STORE (BASEMENT) 900 2500 2400 5.40 m³	2 BED				
EL 7	STORE (INTERNAL) 800 1300 2700 2.81 m ³	BASEMENT 2	STORE (BASEMENT) 950	0 2500	2400	5.70
EL 7	STORE (INTERNAL) 350 1300 2700 1.23 m ³	LEVEL 9	STORE (INTERNAL) 650	0 2400	2700	4.2
	9.44 m³					9.9
-D		902 3.RED				
EMENT 2	STORE (BASEMENT) 900 2500 2400 5.40 m³	2 BED BASEMENT 2	STORE (BASEMENT) 900	0 2500	2400	5.40
EL 7	STORE (BASEMENT) 900 2500 2400 5.40 m ³ STORE (INTERNAL) 300 1900 2700 1.54 m ³	LEVEL 9	STORE (BASEMENT) 900			-
EL 7 EL 7	STORE (INTERNAL) 300 1900 2700 1.54 m ³ STORE (INTERNAL) 400 2335 2700 2.52 m ³	LEVEL 9	STORE (INTERNAL) 350		2700	-
/	9.46 m ³	LLVLLS	OTONE (INTERNAL) 30	J 1300	12100	9.44
	9.40 M²	903				5.44
D		2 BED				_
EMENT 2	STORE (BASEMENT) 1800 1050 2400 4.54 m³	BASEMENT 2	STORE (BASEMENT) 900			5.40
EL 7	STORE (INTERNAL) 600 1100 2700 1.78 m ³	LEVEL 9	STORE (INTERNAL) 300	_		1.54
EL 7	STORE (INTERNAL) 800 1600 2700 3.46 m ³	LEVEL 9	STORE (INTERNAL) 400	0 2335	2700	_
	9.77 m³	904				9.46
ED		2 BED				
SEMENT 2	STORE (BASEMENT) 1200 1400 2400 4.03 m³	BASEMENT 2	STORE (BASEMENT) 180	00 1050	2400	4.54
EL 7	STORE (BASEMENT) 1200 1400 2400 4.03 III STORE (INTERNAL) 800 1300 2700 2.81 m³	LEVEL 9	STORE (INTERNAL) 600			1.78
/EL 7	STORE (INTERNAL) 350 1300 2700 2.01 III	LEVEL 9	STORE (INTERNAL) 800		_	3.46
	8.07 m ³		J. J. L. (11 L. (147L) 000	_ 1000	12,00	9.77
		905				
ED		2 BED				
SEMENT 1	STORE (BASEMENT) 900 2500 2400 5.40 m ³	BASEMENT 2	STORE (BASEMENT) 120	00 1400	2400	4.03
VEL 7	STORE (INTERNAL) 1050 750 2700 2.13 m ³	LEVEL 9	STORE (INTERNAL) 800	0 1300		2.8
/EL 7	STORE (INTERNAL) 450 1600 2700 1.94 m ³	LEVEL 9	STORE (INTERNAL) 350	_		-
,	9.47 m³	906			-	8.07
ED		2 BED				
SEMENT 2	STORE (BASEMENT) 600 2500 2400 3.60 m³	BASEMENT 2	STORE (BASEMENT) 900	0 2500	2400	5.40
VEL 7	STORE (INTERNAL) 650 1125 2700 1.97 m ³	LEVEL 9	STORE (INTERNAL) 10		2700	2.13
/EL 7	STORE (INTERNAL) 300 3600 1000 1.08 m³	LEVEL 9	STORE (INTERNAL) 450	_	_	1.94
	6.65 m³	907				9.47
ΞD		1 BED				
SEMENT 2	STORE (BASEMENT) 950 2500 2400 5.70 m³	BASEMENT 2	STORE (BASEMENT) 600	0 2500	2400	3.60
/EL 8	STORE (INTERNAL) 650 2400 2700 4.21 m³	LEVEL 9	STORE (INTERNAL) 650			
	9.91 m ³	LEVEL 9	STORE (INTERNAL) 300		_	1.08
						6.6
ED	CTODE (DACEMENT) 2000 2000 2000 2000 2000 2000 2000 20	1001				
SEMENT 2 /EL 8	STORE (BASEMENT) 900 2500 2400 5.40 m³	2 BED BASEMENT 2	CTODE (DACEMENT)	0 0500	2400	E 7
	` ' '	LEVEL 10	STORE (BASEMENT) 950 STORE (INTERNAL) 650	_	_	5.70
EL 8	STORE (INTERNAL) 350 1300 2700 1.23 m³ 9.44 m³	LEVEL 10	STORE (INTERNAL) 650	0 2400	2700	9.9
-		1002				
ED .	OTODE (DAOFMENT) and love love love love love love love love	2 BED	OTODE (DASE)	o lace	0::-	le ·
SEMENT 2	STORE (BASEMENT) 900 2500 2400 5.40 m³	BASEMENT 2	STORE (BASEMENT) 900		_	5.40
/EL 8	STORE (INTERNAL) 300 1900 2700 1.54 m³	LEVEL 10	STORE (INTERNAL) 800	_		2.8
/EL 8	STORE (INTERNAL) 400 2335 2700 2.52 m³ 9.46 m³	LEVEL 10	STORE (INTERNAL) 350	1300 ر	2700	9.4
<u>. </u>	55	1003				
ED		2 BED				
SEMENT 2	STORE (BASEMENT) 1800 1050 2400 4.54 m ³	BASEMENT 2	STORE (BASEMENT) 900			5.40
EL 8	STORE (INTERNAL) 600 1100 2700 1.78 m ³	LEVEL 10	STORE (INTERNAL) 300	_	_	1.5
EL 8	STORE (INTERNAL) 800 1600 2700 3.46 m³ 9.77 m³	LEVEL 10	STORE (INTERNAL) 400	0 2335	2700	9.4
	0.77 III	1004				J71
	OTODE (DAGENENTS) 1000 1100 100 100 100	2 BED	OTODE (DAGE) III	00 140=0	0400	14-
	STORE (BASEMENT) 1200 1400 2400 4.03 m³	BASEMENT 2	STORE (BASEMENT) 180			4.5
SEMENT 2		LEVEL 10	STORE (INTERNAL) 600	0 1100	2700	1.78
SEMENT 2 /EL 8	STORE (INTERNAL) 800 1300 2700 2.81 m ³	1 5 5 6 6 6			0-0-	
ED SEMENT 2 /EL 8 /EL 8	STORE (INTERNAL) 800 1300 2700 2.81 m ³ STORE (INTERNAL) 350 1300 2700 1.23 m ³ 8.07 m ³	LEVEL 10	STORE (INTERNAL) 800	0 1600	2700	9.77

		STORAGE SCHEDULE						
Н	VOL		TYPE		D	W	Н	VOL
		1005						
		2 BED					0.00	
100	5.40 m ³	BASEMENT 2	STORE (BASEM			1400		4.03 m ³
700 700	2.13 m ³ 1.94 m ³	LEVEL 10 LEVEL 10	STORE (INTERN		800 350		2700 2700	2.81 m ³ 1.23 m ³
00	9.47 m ³	LLVLL IV	310KL (INTLKN	IAL)	330	1300	2700	8.07 m ³
		1006						
		2 BED						
100	3.60 m ³	BASEMENT 2	STORE (BASEM		900	2500	_	5.40 m ³
700 000	1.97 m ³ 1.08 m ³	LEVEL 10 LEVEL 10	STORE (INTERN		1050 450	750 1600	2700 2700	2.13 m ³ 1.94 m ³
JUU	6.65 m ³	LEVEL 10	STORE (INTERN	(AL)	430	1000	2700	9.47 m ³
		1007						
		1 BED						
100	5.70 m ³	BASEMENT 2	STORE (BASEM	-/-	600		2400	3.60 m ³
700	4.21 m³	LEVEL 10	STORE (INTERN		650	_	2700	1.97 m ³
	9.91 m³	LEVEL 10	STORE (INTERN	IAL)	300	3600	1000	1.08 m ³ 6.65 m ³
		1101						0.03111
100	5.40 m ³	2 BED						
700	2.81 m ³	BASEMENT 2	STORE (BASEM	ENT)	950	2500	2400	5.70 m ³
700	1.23 m ³	LEVEL 11	STORE (INTERN	IAL)	650	2400	2700	4.21 m ³
	9.44 m³	4400						9.91 m ³
		1102 2 BED						
100	5.40 m³	BASEMENT 2	STORE (BASEM	FNT)	900	2500	2400	5.40 m³
700	1.54 m ³	LEVEL 11	STORE (INTERN		800	1300	2700	2.81 m ³
700	2.52 m ³	LEVEL 11	STORE (INTERN	IAL)	350	1300	2700	1.23 m ³
	9.46 m³							9.44 m³
		1103						
100	454 3	2 BED	OTODE (DAGEN	ENT	000	0500	0.400	F 40 3
100 700	4.54 m ³ 1.78 m ³	BASEMENT 2 LEVEL 11	STORE (BASEM) STORE (INTERN		900 300	_	2400	5.40 m ³ 1.54 m ³
700	3.46 m ³	LEVEL 11	STORE (INTERN		400		2700	2.52 m ³
00	9.77 m ³	LLVLL II	OTORE (NATERIA	enc) [700	2000	2700	9.46 m ³
		1104						
		2 BED						
	4.03 m ³	BASEMENT 2	STORE (BASEM		1800	1050	_	4.54 m³
700	2.81 m ³	LEVEL 11	STORE (INTERN	-/-	600	1100	2700	1.78 m³
700	1.23 m ³ 8.07 m ³	LEVEL 11	STORE (INTERN	IAL)	800	1600	2700	3.46 m ³ 9.77 m ³
	0.07 111	1105						9.77 111
		2 BED						
100	5.40 m ³	BASEMENT 2	STORE (BASEM	ENT)	1200	1400	2400	4.03 m ³
700	2.13 m ³	LEVEL 11	STORE (INTERN	IAL)	800	1300	2700	2.81 m ³
700	1.94 m³	LEVEL 11	STORE (INTERN	IAL)	350	1300	2700	1.23 m ³
	9.47 m³	4400						8.07 m ³
		1106 2 BED						
100	3.60 m ³	BASEMENT 2	STORE (BASEM	ENT)	900	2500	2400	5.40 m³
700	1.97 m ³	LEVEL 11	STORE (INTERN		1050	_	2700	2.13 m ³
000	1.08 m ³	LEVEL 11	STORE (INTERN	IAL)	450	1600	2700	1.94 m³
	6.65 m³			·				9.47 m ³
		1107						
100	F 703	1 BED	OTODE (BACEM	ENT	0200	4250	0.400	7.453
100 700	5.70 m ³ 4.21 m ³	BASEMENT 2 LEVEL 11	STORE (BASEM) STORE (INTERN	-/-	2300 650	1350	2700	7.45 m ³ 1.97 m ³
00	9.91 m ³	LEVEL 11	STORE (INTERN		300	_		1.08 m ³
	0.01		1010112 (111121111	, _	-	10000	1.000	10.51 m ³
		1201						
100	5.40 m ³	2 BED						
		BASEMENT 2	STORE (BASEM			_	2400	5.70 m ³
700	2.81 m ³		STORE (INTERN	IAL) I	650	2400	2700	4.21 m³
	2.81 m³ 1.23 m³	LEVEL 12	OTOTAL (INTERNA					
700	2.81 m ³		TOTOTAL (IIVILIAN					9.91 m³
700	2.81 m³ 1.23 m³	1202	TOTORE (INTERNA				•	9.91 m³
700	2.81 m³ 1.23 m³		STORE (BASEM)		900	2500	2400	9.91 m ³
700 700	2.81 m³ 1.23 m³ 9.44 m³	1202 2 BED		ENT)	900		2400 2700	
700 700 400	2.81 m ³ 1.23 m ³ 9.44 m ³ 5.40 m ³	1202 2 BED BASEMENT 2	STORE (BASEM	ENT)		1300	2700	5.40 m³ 2.81 m³ 1.23 m³
700 700 400 700	2.81 m ³ 1.23 m ³ 9.44 m ³ 5.40 m ³ 1.54 m ³	1202 2 BED BASEMENT 2 LEVEL 12 LEVEL 12	STORE (BASEM)	ENT)	800	1300	2700	5.40 m³ 2.81 m³
700 700 400 700	2.81 m ³ 1.23 m ³ 9.44 m ³ 5.40 m ³ 1.54 m ³ 2.52 m ³	1202 2 BED BASEMENT 2 LEVEL 12 LEVEL 12	STORE (BASEM)	ENT)	800	1300	2700	5.40 m³ 2.81 m³ 1.23 m³
700 700 400 700 700	2.81 m ³ 1.23 m ³ 9.44 m ³ 5.40 m ³ 1.54 m ³ 2.52 m ³ 9.46 m ³	1202 2 BED BASEMENT 2 LEVEL 12 LEVEL 12 1203 2 BED	STORE (BASEM) STORE (INTERN STORE (INTERN	ENT) IAL) IAL)	800 350	1300 1300	2700 2700	5.40 m³ 2.81 m³ 1.23 m³ 9.44 m³
700 700 400 700 700 400	2.81 m³ 1.23 m³ 9.44 m³ 5.40 m³ 1.54 m³ 2.52 m³ 9.46 m³	1202 2 BED BASEMENT 2 LEVEL 12 LEVEL 12 1203 2 BED BASEMENT 2	STORE (BASEM) STORE (INTERN STORE (INTERN	ENT) IAL) IAL)	800 350 900	1300 1300 2500	2700 2700 2400	5.40 m³ 2.81 m³ 1.23 m³ 9.44 m³
700 700 400 700 700	2.81 m ³ 1.23 m ³ 9.44 m ³ 5.40 m ³ 1.54 m ³ 2.52 m ³ 9.46 m ³	1202 2 BED BASEMENT 2 LEVEL 12 LEVEL 12 1203 2 BED	STORE (BASEM) STORE (INTERN STORE (INTERN	ENT) IAL) ENT) IAL)	800 350	1300 1300 2500	2700 2700 2400 2700	5.40 m³ 2.81 m³ 1.23 m³ 9.44 m³

1204	TYPE	D	W	Н	VOL
1204					
2 BED					
BASEMENT 2	STORE (BASEMENT)		_	2400	_
LEVEL 12	STORE (INTERNAL)	600	1100		1.78 m ³
LEVEL 12	STORE (INTERNAL)	800	1600	2700	3.46 m ³
1205					9.77 m ³
2 BED	OTODE (DAOENENT)	1000	4000	0.400	1400 2
BASEMENT 2	STORE (BASEMENT) STORE (INTERNAL)	_	1800		4.32 m ³
LEVEL 12 LEVEL 12	STORE (INTERNAL)	800 350	_	2700 2700	2.81 m ³ 1.23 m ³
LLVLL 12	STOKE (INTERNAL)	1000	1300	2700	8.36 m ³
1206 2 BED					
BASEMENT 2	STORE (BASEMENT)	900	2500	2400	5.40 m ³
LEVEL 12	STORE (INTERNAL)	1050	750	2700	2.13 m ³
LEVEL 12	STORE (INTERNAL)	450	1600	2700	1.94 m ³
1207					9.47 m ³
1 BED					
BASEMENT 2	STORE (BASEMENT)	_	1350		7.61 m ³
LEVEL 12	STORE (INTERNAL)	650	-	2700	1.97 m ³
LEVEL 12	STORE (INTERNAL)	300	3600	1000	1.08 m ³
1301					10.67 m
2 BED		10.0-			T==-
BASEMENT 2	STORE (BASEMENT)	_	_		5.70 m ³
LEVEL 13	STORE (INTERNAL)	650	2400	2700	4.21 m ³ 9.91 m ³
1302					9.91 m
2 BED	CTODE (DACELIELE)	000	2500	0400	E 40 ^
BASEMENT 2	STORE (BASEMENT)	_		2400	_
LEVEL 13 LEVEL 13	STORE (INTERNAL) STORE (INTERNAL)	800 350	1300	2700 2700	2.81 m ³ 1.23 m ³
LEVEL 13	310KE (INTERNAL)	330	1300	2700	9.44 m ³
1303					
2 BED	T	1			I
BASEMENT 2	STORE (BASEMENT)	_	_	2400	5.40 m ³
LEVEL 13	STORE (INTERNAL)	300	1900	2700	1.54 m ³
LEVEL 13	STORE (INTERNAL)	400	2335	2700	2.52 m ³ 9.46 m ³
1304					
2 BED	OTODE (DAGEMENT)	4000	4050	0.400	4.543
BASEMENT 2 LEVEL 13	STORE (BASEMENT) STORE (INTERNAL)	1800	1100	2400 2700	4.54 m ³ 1.78 m ³
LEVEL 13	STORE (INTERNAL)	800	1600	2700	3.46 m ³
LLVLL 10	OTOTIC (INTERNAL)	1000	1000	2700	9.77 m ³
1305 2 BED					
BASEMENT 2	STORE (BASEMENT)	1000	1800	2400	4.32 m ³
LEVEL 13	STORE (INTERNAL)	800	1300		2.81 m ³
LEVEL 12	STORE (INTERNAL)	350	1300	2700	1.23 m ³
LEVEL 13					8.36 m ³
1306 2 BED					
1306	STORE (BASEMENT)		2500	2400	5.40 m ³
1306 2 BED BASEMENT 2 LEVEL 13	STORE (INTERNAL)	1050	750	2700	2.13 m ³
1306 2 BED BASEMENT 2	, ,				2.13 m ³ 1.94 m ³
1306 2 BED BASEMENT 2 LEVEL 13	STORE (INTERNAL)	1050	750	2700	2.13 m ³ 1.94 m ³
1306 2 BED BASEMENT 2 LEVEL 13 LEVEL 13 1307 1 BED	STORE (INTERNAL) STORE (INTERNAL)	1050 450	750 1600	2700 2700	2.13 m ³ 1.94 m ³ 9.47 m ³
1306 2 BED BASEMENT 2 LEVEL 13 LEVEL 13 1307 1 BED BASEMENT 2	STORE (INTERNAL) STORE (INTERNAL) STORE (BASEMENT)	1050 450 2300	750 1600 1350	2700 2700 2400	2.13 m ³ 1.94 m ³ 9.47 m ³ 7.45 m ³
1306 2 BED BASEMENT 2 LEVEL 13 LEVEL 13 1307 1 BED BASEMENT 2 LEVEL 13	STORE (INTERNAL) STORE (INTERNAL) STORE (BASEMENT) STORE (INTERNAL)	1050 450 2300 650	750 1600 1350 1125	2700 2700 2400 2700	2.13 m ³ 1.94 m ³ 9.47 m ³ 7.45 m ³ 1.97 m ³
1306 2 BED BASEMENT 2 LEVEL 13 LEVEL 13 1307 1 BED BASEMENT 2	STORE (INTERNAL) STORE (INTERNAL) STORE (BASEMENT)	1050 450 2300	750 1600 1350	2700 2700 2400	2.13 m ³ 1.94 m ³ 9.47 m ³ 7.45 m ³ 1.97 m ³
1306 2 BED BASEMENT 2 LEVEL 13 LEVEL 13 1307 1 BED BASEMENT 2 LEVEL 13 LEVEL 13	STORE (INTERNAL) STORE (INTERNAL) STORE (BASEMENT) STORE (INTERNAL)	1050 450 2300 650	750 1600 1350 1125	2700 2700 2400 2700	2.13 m ³ 1.94 m ³ 9.47 m ³ 7.45 m ³ 1.97 m ³ 1.08 m ³
1306 2 BED BASEMENT 2 LEVEL 13 LEVEL 13 1307 1 BED BASEMENT 2 LEVEL 13 LEVEL 13 1401 2 BED	STORE (INTERNAL) STORE (INTERNAL) STORE (BASEMENT) STORE (INTERNAL) STORE (INTERNAL)	2300 650 300	750 1600 1350 1125 3600	2700 2700 2400 2700 1000	2.13 m ³ 1.94 m ³ 9.47 m ³ 7.45 m ³ 1.97 m ³ 1.08 m ³
1306 2 BED BASEMENT 2 LEVEL 13 LEVEL 13 1307 1 BED BASEMENT 2 LEVEL 13 LEVEL 13 1401 2 BED BASEMENT 2	STORE (INTERNAL) STORE (INTERNAL) STORE (BASEMENT) STORE (INTERNAL) STORE (INTERNAL) STORE (BASEMENT)	2300 650 300	750 1600 1350 1125 3600	2700 2700 2400 2700 1000	2.13 m ³ 1.94 m ³ 9.47 m ³ 7.45 m ³ 1.97 m ³ 1.08 m ³ 10.51 m
1306 2 BED BASEMENT 2 LEVEL 13 LEVEL 13 1307 1 BED BASEMENT 2 LEVEL 13 1401 2 BED BASEMENT 2 LEVEL 14	STORE (INTERNAL) STORE (INTERNAL) STORE (BASEMENT) STORE (INTERNAL) STORE (INTERNAL)	2300 650 300	750 1600 1350 1125 3600	2700 2700 2400 2700 1000	2.13 m ³ 1.94 m ³ 9.47 m ³ 7.45 m ³ 1.97 m ³ 1.08 m ³ 10.51 m 5.70 m ³ 4.21 m ³
1306 2 BED BASEMENT 2 LEVEL 13 LEVEL 13 1307 1 BED BASEMENT 2 LEVEL 13 LEVEL 13 1401 2 BED BASEMENT 2	STORE (INTERNAL) STORE (INTERNAL) STORE (BASEMENT) STORE (INTERNAL) STORE (INTERNAL) STORE (BASEMENT)	2300 650 300	750 1600 1350 1125 3600	2700 2700 2400 2700 1000	5.40 m ³ 2.13 m ³ 1.94 m ³ 9.47 m ³ 7.45 m ³ 1.08 m ³ 10.51 m 5.70 m ³ 4.21 m ³ 9.91 m ³
1306 2 BED BASEMENT 2 LEVEL 13 LEVEL 13 1307 1 BED BASEMENT 2 LEVEL 13 1401 2 BED BASEMENT 2 LEVEL 14	STORE (INTERNAL) STORE (INTERNAL) STORE (BASEMENT) STORE (INTERNAL) STORE (INTERNAL) STORE (BASEMENT)	2300 650 300 950 650	750 1600 1350 1125 3600 2500 2400	2400 2700 2700 1000 2400 2400 2700	2.13 m ³ 1.94 m ³ 9.47 m ³ 7.45 m ³ 1.97 m ³ 1.08 m ³ 10.51 m 5.70 m ³ 4.21 m ³
1306 2 BED BASEMENT 2 LEVEL 13 LEVEL 13 1307 1 BED BASEMENT 2 LEVEL 13 LEVEL 13 1401 2 BED BASEMENT 2 LEVEL 14 1402 3 BED	STORE (INTERNAL) STORE (INTERNAL) STORE (BASEMENT) STORE (INTERNAL) STORE (INTERNAL) STORE (INTERNAL) STORE (BASEMENT) STORE (INTERNAL)	2300 650 300 950 650	750 1600 1350 1125 3600 2500 2400	2400 2700 2700 1000 2400 2400 2700	2.13 m ³ 1.94 m ³ 9.47 m ³ 7.45 m ³ 1.97 m ³ 1.08 m ³ 10.51 m 5.70 m ³ 4.21 m ³ 9.91 m ³
1306 2 BED BASEMENT 2 LEVEL 13 LEVEL 13 1307 1 BED BASEMENT 2 LEVEL 13 LEVEL 13 LEVEL 13 LEVEL 13 LEVEL 14 1401 2 BED BASEMENT 2 LEVEL 14 1402 3 BED BASEMENT 2	STORE (INTERNAL) STORE (INTERNAL) STORE (BASEMENT) STORE (INTERNAL) STORE (INTERNAL) STORE (BASEMENT) STORE (INTERNAL) STORE (INTERNAL)	1050	750 1600 1350 1125 3600 2500 2400	2400 2700 2400 2700 1000 2400 2700 2400 2700	2.13 m ³ 1.94 m ³ 9.47 m ³ 7.45 m ³ 1.97 m ³ 1.08 m ³ 10.51 m 5.70 m ³ 4.21 m ³ 9.91 m ³

STORAGE SCHEDULE

	TYPE	D	w	Н
	IIFE		***	
1403				
3 BED				
BASEMENT 2	STORE (BASEMENT)	1500	1500	2400
LEVEL 14	STORE (INTERNAL)	600	1205	2700
LEVEL 14	STORE (INTERNAL)	800	1300	2700
LEVEL 14	STORE (INTERNAL)	350	700	2700
1404				
2 BED	_			
BASEMENT 1	STORE (BASEMENT)	_	2850	
LEVEL 14	STORE (INTERNAL)	1050	_	2700
LEVEL 14	STORE (INTERNAL)	450	1600	2700
1405				
1 BED	OTODE (DAGENE: T	000	0500	0.400
BASEMENT 2	STORE (BASEMENT)	900	2500	
LEVEL 14	STORE (INTERNAL)	650	1125	2700
LEVEL 14	STORE (INTERNAL)	300	3600	1000
1501				
1501 2 PED				
2 BED	OTODE (DACEMENT)	050	0500	0.400
BASEMENT 2	STORE (BASEMENT)	_		2400
LEVEL 15	STORE (INTERNAL)	650	2400	2700
1502				
3 BED				
BASEMENT 2	STORE (BASEMENT)	1500	1500	2400
LEVEL 15	STORE (INTERNAL)	600	1205	
		800	1300	2700
LEVEL 15 LEVEL 15	STORE (INTERNAL)	350	700	2700
LEVEL 13	STORE (INTERNAL)	330	700	2700
1503				
3 BED				
BASEMENT 2	STORE (BASEMENT)	1500	1500	2400
LEVEL 15	STORE (INTERNAL)	600	_	2700
LEVEL 15 LEVEL 15	STORE (INTERNAL)	800	1300	_
LEVEL 15	STORE (INTERNAL)	350	700	2700
	CICIAL (HAILIMAL)	1000	1,00	2,00
1504				
2 BED				
BASEMENT 1	STORE (BASEMENT)	700	2850	2400
LEVEL 15	STORE (INTERNAL)	1050		2700
LEVEL 15	STORE (INTERNAL)	450	1600	
-	- ("-)			
1505				
1 BED		900	2500	2400
	STORE (BASEMENT)		1	
BASEMENT 2	STORE (BASEMENT) STORE (INTERNAL)	_	11125	2700
1 BED BASEMENT 2 LEVEL 15 LEVEL 15	STORE (INTERNAL)	650		
BASEMENT 2	, ,	_	1125 3600	1000
BASEMENT 2 LEVEL 15 LEVEL 15	STORE (INTERNAL)	650		
BASEMENT 2 LEVEL 15 LEVEL 15	STORE (INTERNAL)	650		
BASEMENT 2 LEVEL 15 LEVEL 15 1601 4 BED	STORE (INTERNAL) STORE (INTERNAL)	650 300	3600	1000
BASEMENT 2 LEVEL 15 LEVEL 15	STORE (INTERNAL)	650		1000

DISCLATINER

Subject to: full site survey, measurements are preliminary, discussions and meetings with authorities, approval from authorities relevant consultant information as per council DA requirements. Feasibility completed based on information provided by client. Drawings are not are not suitable for purchase of property.

All parting and ramps to traffic engineers details. (Subject to Approval)

iii parkirig	and ramps to train	ic engineers details. (Subject to Appr	ovai)
REF.	DATE	AMENDMENT	
P	04.11.2021	CONSULTANT ISSUE	
Q	02.12.2021	DA SUBMISSION	
T	24.06.2022	CLIENT REVIEW	
U	04.07.2022	ADDITIONAL INFORMATION	
W	19.07.2022	ADDITIONAL INFORMATION	
DISCLAIN			
All dimensions a	are in millimeters. Verify all d	timensions on site prior to commencement of any work.	DESIGN WORKSHOP AUST



Wollongong 81a Princes Highway, Fairy Meadow NSW 2519 Tel: (02) 4227 1661

Email: info@designworkshop.com.au Web: www.designworkshop.com.au

Sydney Level 10, 6 Mount Olympus Boulevard, Wolli Creek NSW 2205 Nominated Architect: Robert Gizzi (Reg. 8286)

CLIENT:

DRAWING NAME: STORAGE SCHEDULE

ANYA SOLUTION Pty Ltd MIXED USE DEVELOPMENT 24-30 KENNY STREET, WOLLONGONG, NSW

ADDITIONAL INFORMATION

ISSUE D	DATE: 28.11.2022	PROJECT N 2289	No.
DRAWN	l: AK	2209	
SCALE:		DWG No.	Rev.
QA:	RG	029	BB

| 1002 | 4 BED | BASEMENT | 2750 | 2200 | 2400 | 14.52 m³ | 1204 |



AMENDMENT CONSULTANT ISSUE DATE 04.11.2021 02.12.2021 24.06.2022 DA SUBMISSION CLIENT REVIEW ADDITIONAL INFORMATION 04.07.2022

DESIGN WORKSHOP AUSTRALIA

Wollongong 81a Princes Highway, Fairy Meadow NSW 2519 Tel: (02) 4227 1661 Email: info@designworkshop.com.au


Web: www.designworkshop.com.au

Sydney Level 10, 6 Mount Olympus Boulevard, Wolli Creek NSW 2205 Nominated Architect: Robert Gizzi (Reg. 8286)


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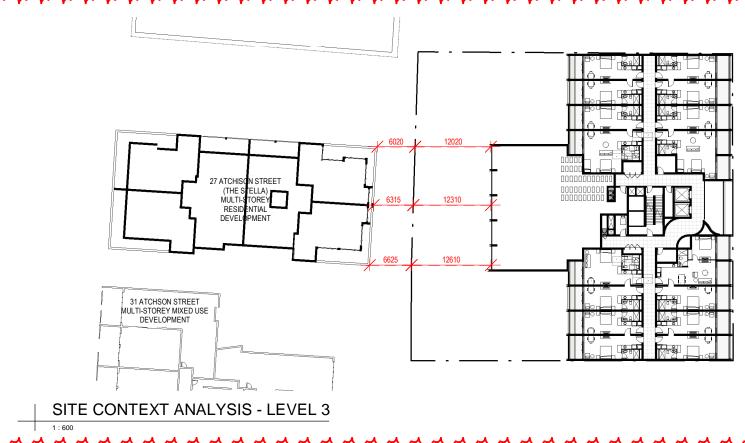
ANYA SOLUTION Pty Ltd MIXED USE DEVELOPMENT 24-30 KENNY STREET, WOLLONGONG, NSW DRAWING NAME: SITE CONTEXT - KEY FLOOR PLANS

ADDITIONAL INFORMATION

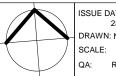

ISSUE DATE: PROJECT No. 28.11.2022 2289 DWG No. Rev. 030 ВВ



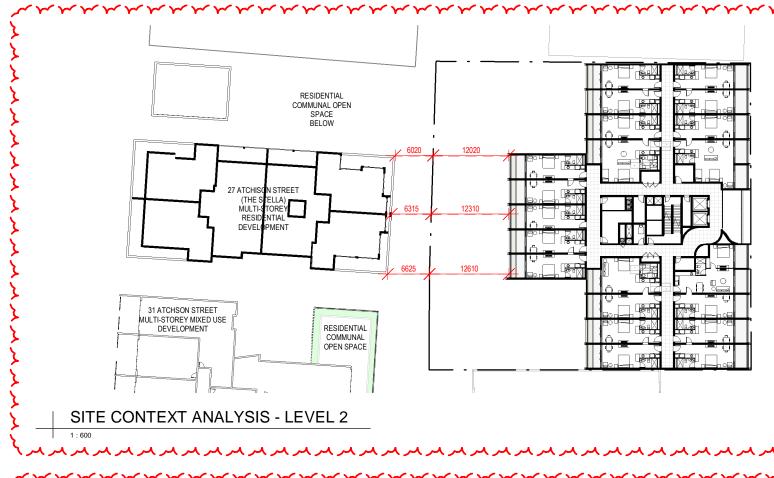

AMENDMENT CONSULTANT ISSUE DATE 04.11.2021 02.12.2021 24.06.2022 DA SUBMISSION CLIENT REVIEW ADDITIONAL INFORMATION 04.07.2022

DESIGN WORKSHOP AUSTRALIA

Wollongong 81a Princes Highway, Fairy Meadow NSW 2519 Tel: (02) 4227 1661 Email: info@designworkshop.com.au

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Sydney Level 10, 6 Mount Olympus Boulevard, Wolli Creek NSW 2205 Nominated Architect: Robert Gizzi (Reg. 8286)

CLIENT: ADDRESS:

ANYA SOLUTION Pty Ltd MIXED USE DEVELOPMENT 24-30 KENNY STREET, WOLLONGONG, NSW


DRAWING NAME: SITE CONTEXT - KEY FLOOR PLANS

ADDITIONAL INFORMATION



ISSUE DATE: 28.11.2022 SCALE: QA:

PROJECT No. 2289 DWG No. Rev. 031 BB

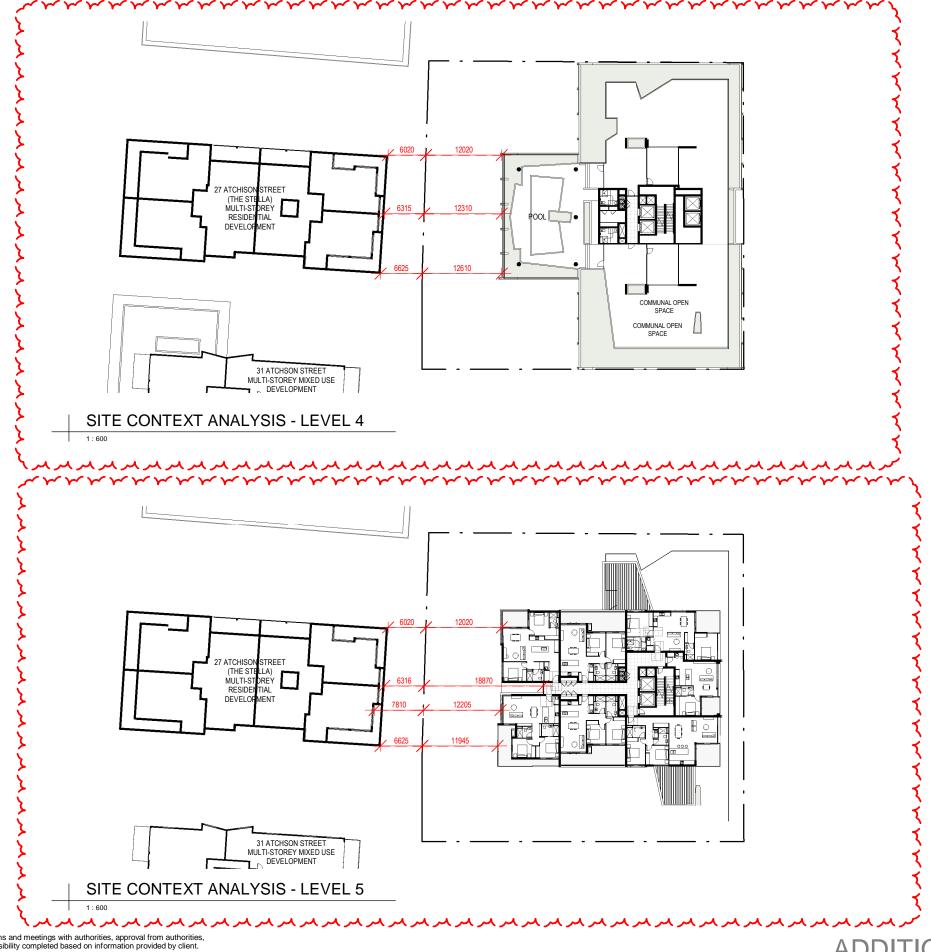

AMENDMENT
CONSULTANT ISSUE
DA SUBMISSION
CLIENT REVIEW DATE 04.11.2021 02.12.2021 24.06.2022 ADDITIONAL INFORMATION 04.07.2022

Wollongong 81a Princes Highway, Fairy Meadow NSW 2519 Tel: (02) 4227 1661 Email: info@designworkshop.com.au

Web: www.designworkshop.com.au

Sydney Level 10, 6 Mount Olympus Boulevard, Wolli Creek NSW 2205 Nominated Architect: Robert Gizzi (Reg. 8286)

CLIENT: ADDRESS:


ANYA SOLUTION Pty Ltd MIXED USE DEVELOPMENT 24-30 KENNY STREET, WOLLONGONG, NSW DRAWING NAME: SITE CONTEXT - KEY FLOOR PLANS

ADDITIONAL INFORMATION



ISSUE DATE: 28.11.2022 SCALE:

PROJECT No. 2289 DWG No. Rev. 032 ВВ

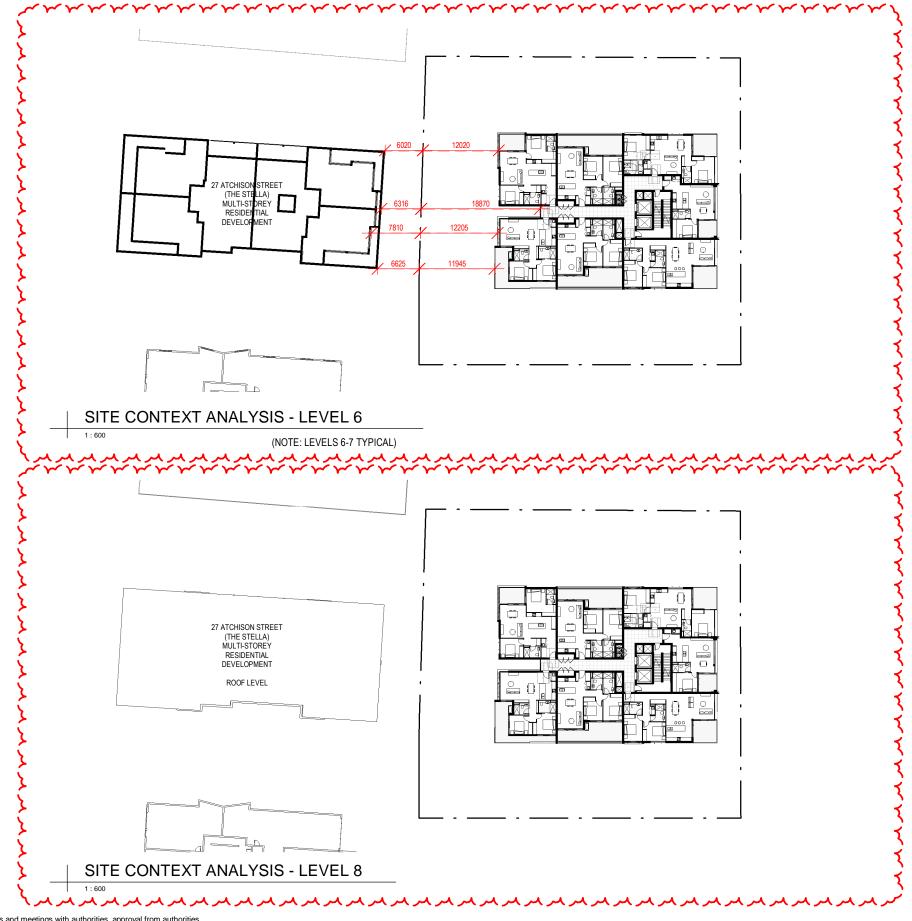

AMENDMENT
CONSULTANT ISSUE
DA SUBMISSION
CLIENT REVIEW DATE 04.11.2021 02.12.2021 24.06.2022 ADDITIONAL INFORMATION 04.07.2022

Wollongong 81a Princes Highway, Fairy Meadow NSW 2519 Tel: (02) 4227 1661 Email: info@designworkshop.com.au

Web: www.designworkshop.com.au

Sydney Level 10, 6 Mount Olympus Boulevard, Wolli Creek NSW 2205 Nominated Architect: Robert Gizzi (Reg. 8286)

CLIENT: ADDRESS:

ANYA SOLUTION Pty Ltd MIXED USE DEVELOPMENT 24-30 KENNY STREET, WOLLONGONG, NSW


DRAWING NAME: SITE CONTEXT - KEY FLOOR PLANS

ADDITIONAL INFORMATION



ISSUE DATE: 28.11.2022 DRAWN: NT SCALE:

PROJECT No. 2289 DWG No. Rev. 033 ВВ

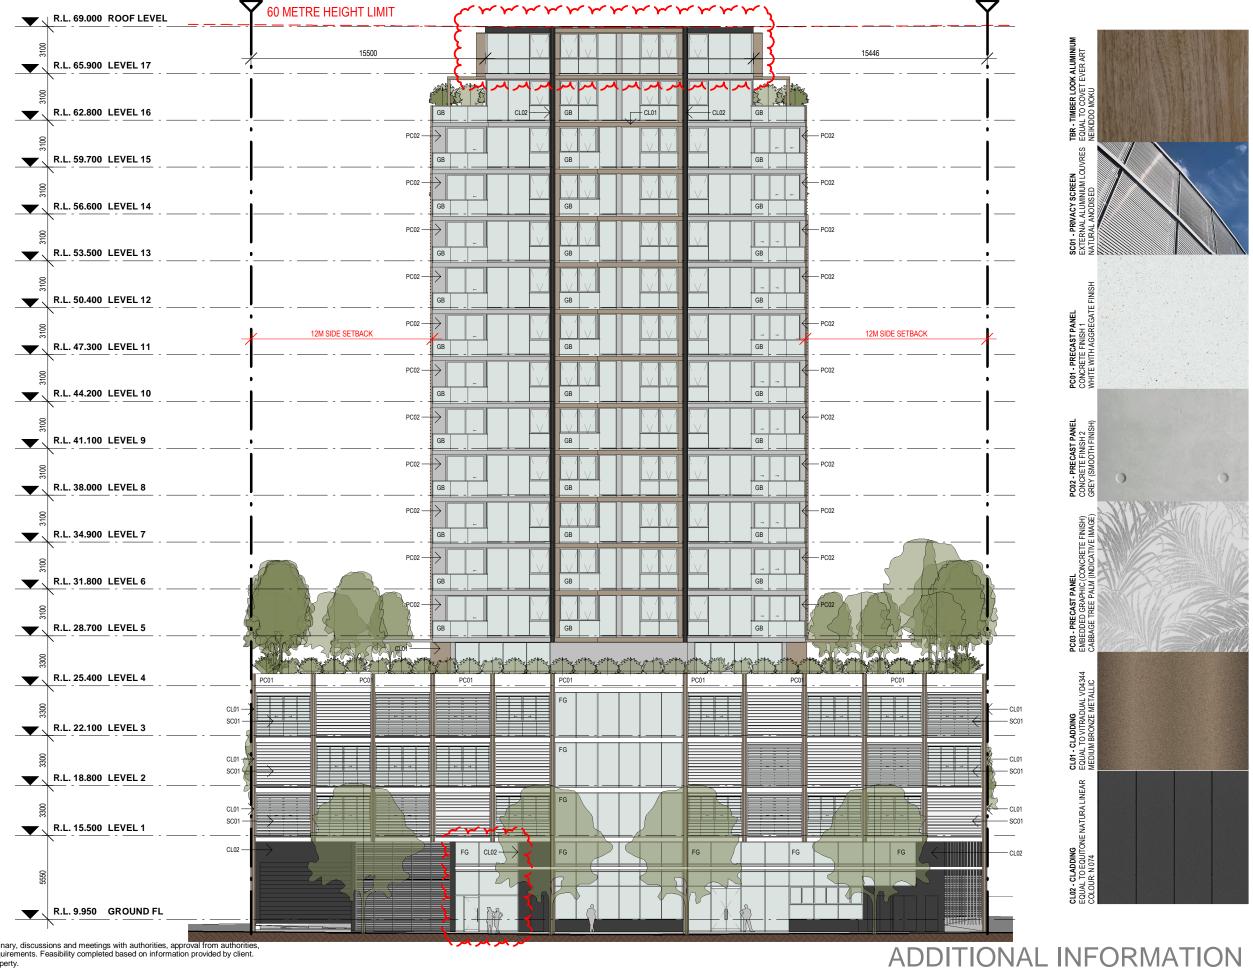

DISCLATIVIER
Subject to: full site survey, measurements are preliminary, discussions and meetings with authorities, approval from authorities, relevant consultant information as per council DA requirements. Feasibility completed based on information provided by client. Drawings are not are not suitable for purchase of property.

All parking and ramps to traffic engineers details. (Subject to Approval)

AMENDMENT CLIENT REVIEW 24.06.2022 04.07.2022 19.07.2022 ADDITIONAL INFORMATION ADDITIONAL INFORMATION 18.11.2022 PRELIMINARY 7 23.11.2022 PRELI
DISCLAIMER
All dimensions are in millimeters. Verify all dimensions on site prior to

ment of any work. DESIGN WORKSHOP AUSTRALIA

Wollongong 81a Princes Highway, Fairy Meadow NSW 2519 Tel: (02) 4227 1661 Email: info@designworkshop.com.au


Sydney Level 10, 6 Mount Olympus Boulevard, Wolli Creek NSW 2205 Nominated Architect: Web: www.designworkshop.com.au Robert Gizzi (Reg. 8286)


ANYA SOLUTION Pty Ltd MIXED USE DEVELOPMENT CLIENT: 24-30 KENNY STREET, WOLLONGONG, NSW DRAWING NAME: ELEVATION - EAST

SCALE BAR: 5 7.5 10 12.5m

ISSUE DATE: PROJECT No. 2289 DRAWN: AK DWG No. Rev. SCALE: 1:250

QA: RG

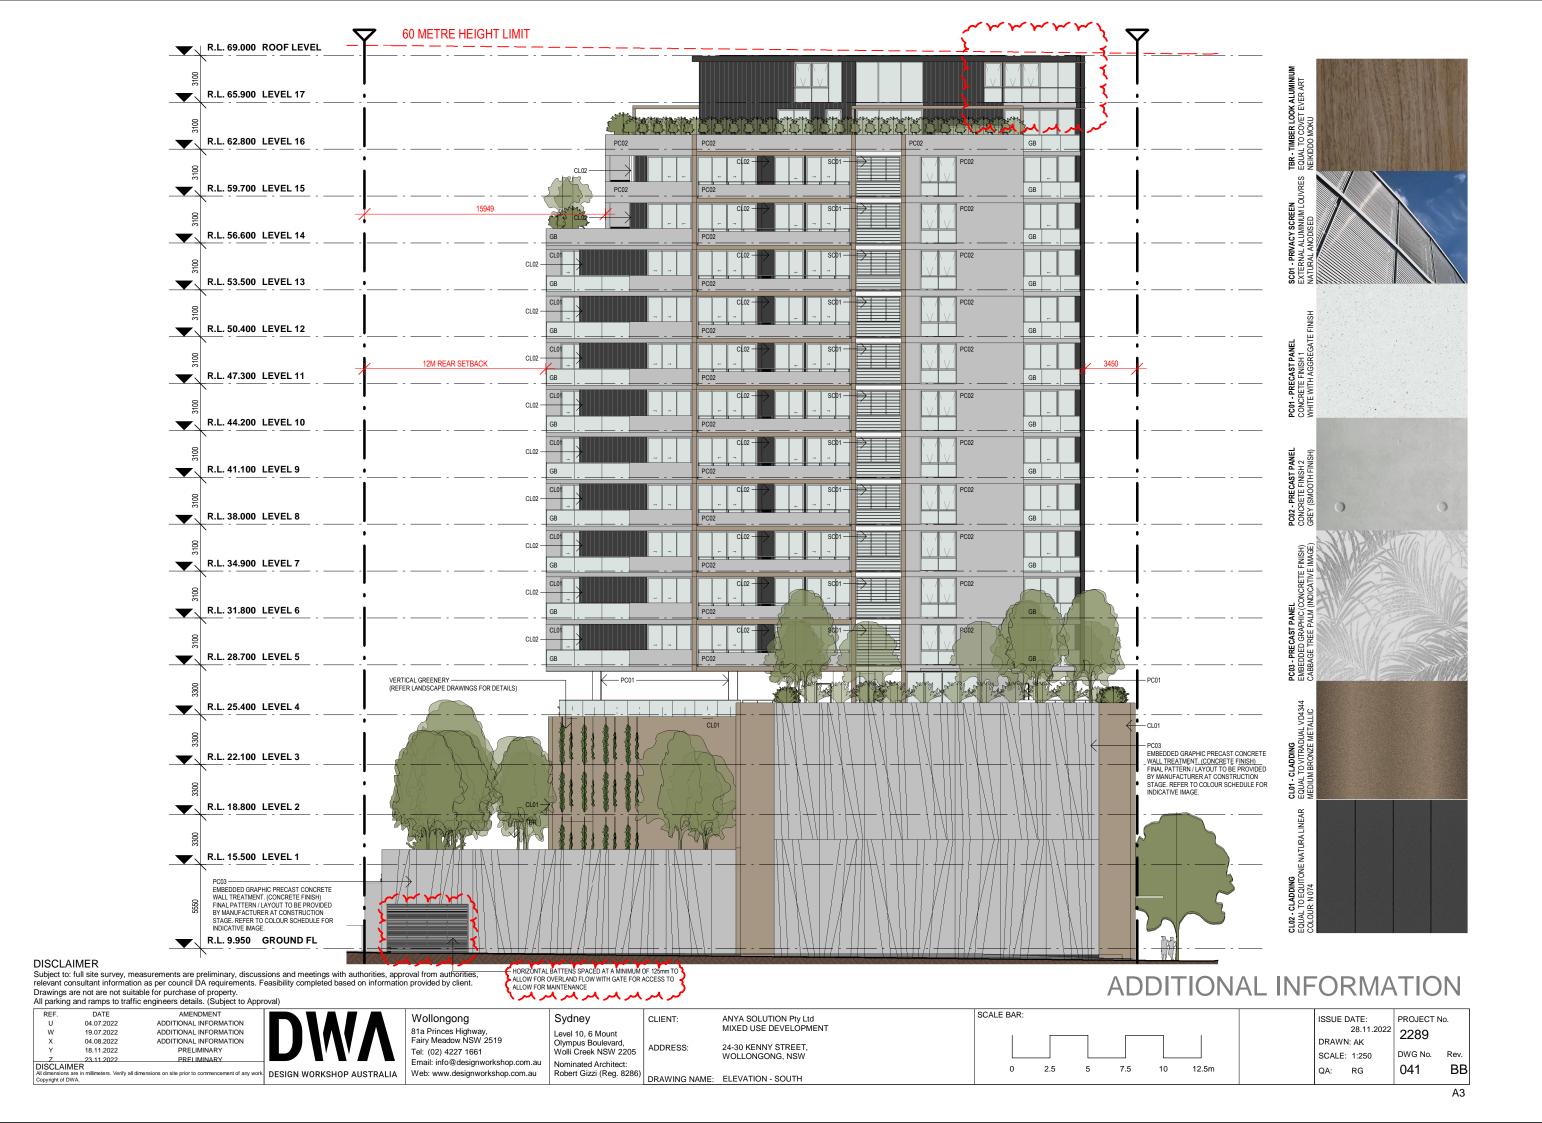

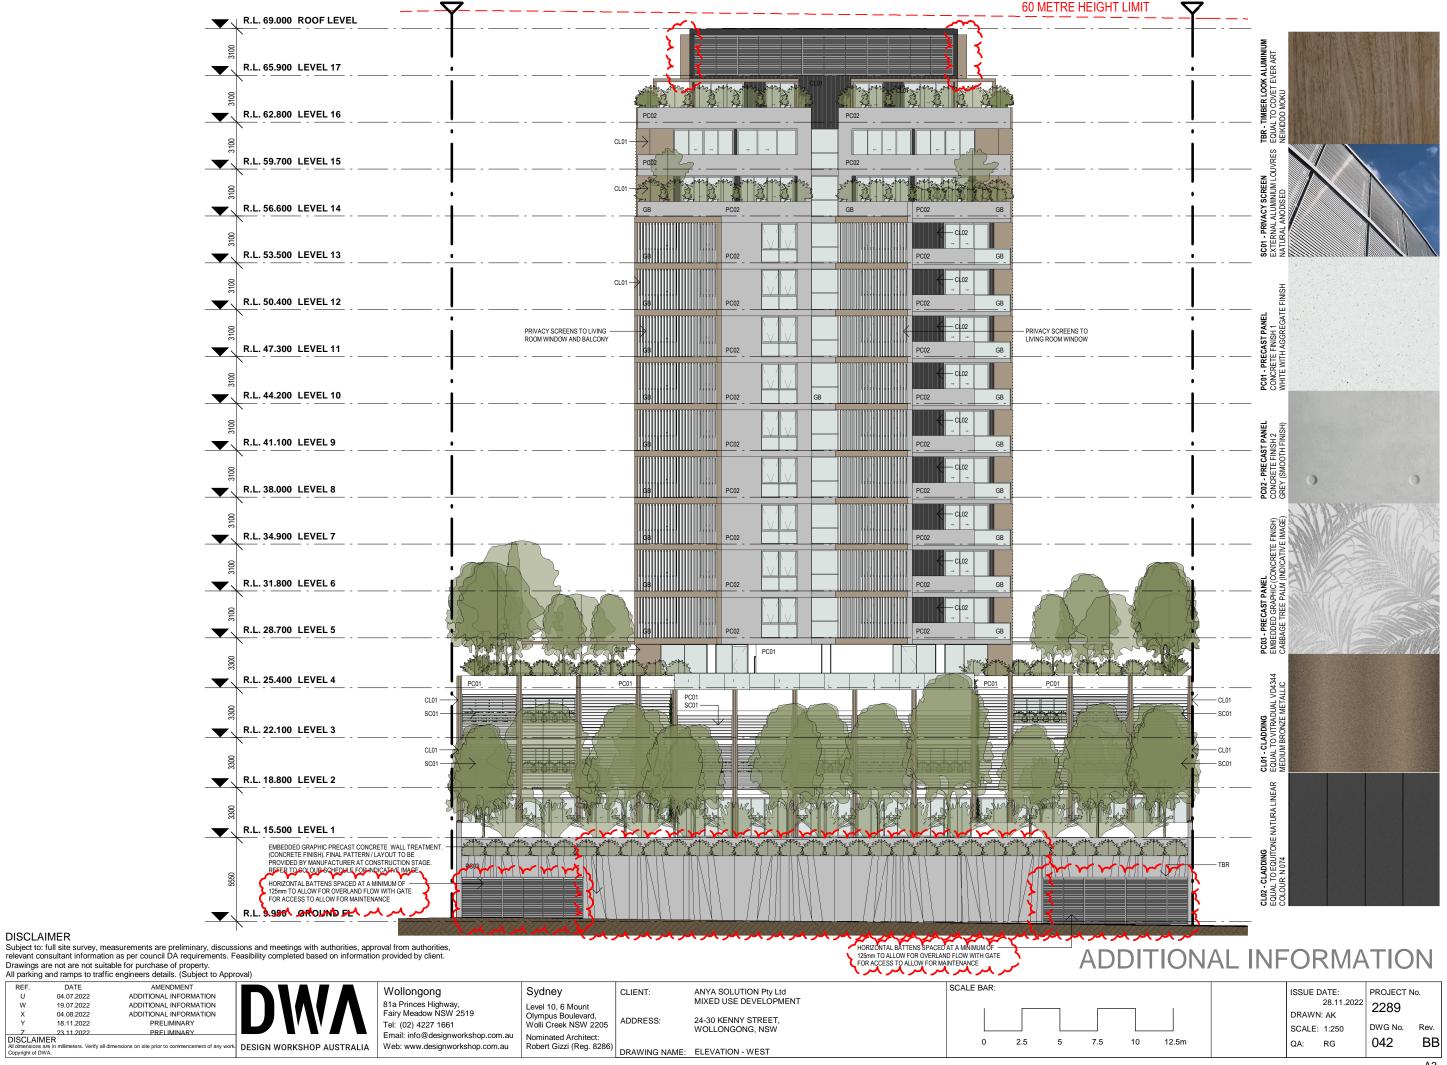


DISCLAIMER

04.07.2022

19.07.2022 04.08.2022

18.11.2022

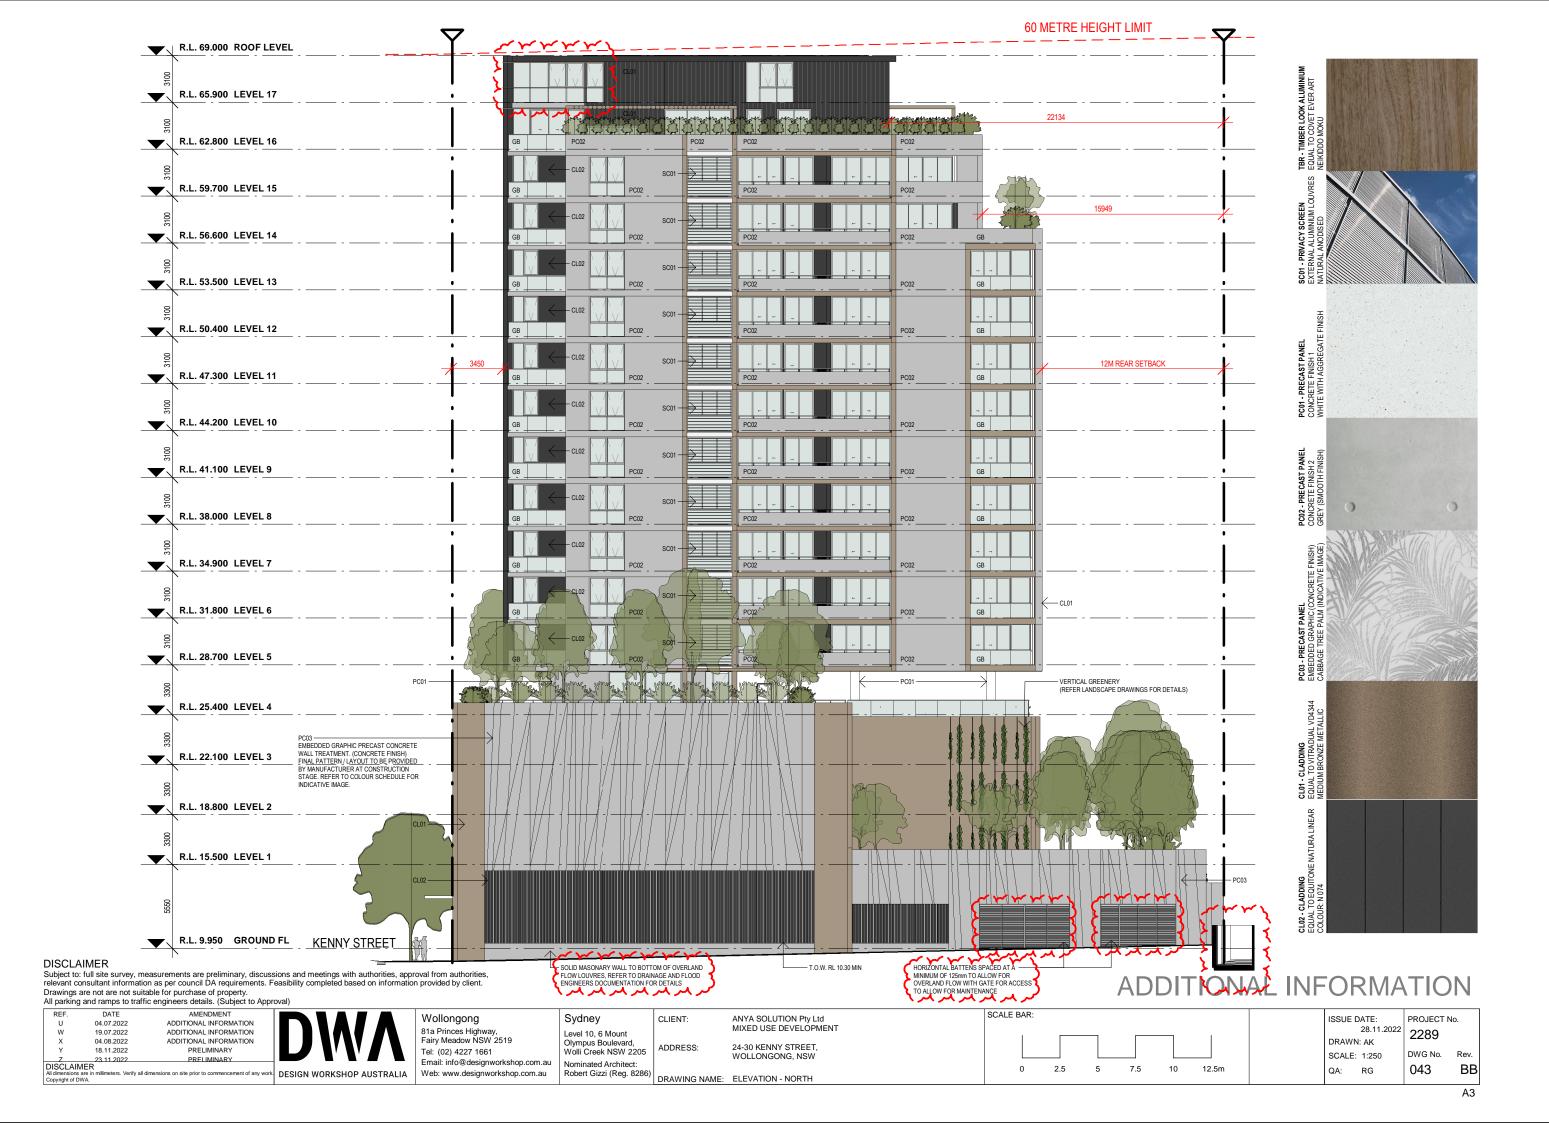

HOTEL JE E 2 BED 1306 2 BED 806 2 BED 1404 2 BED 1206 2 BED 1006 BED 906 906 606 2 BED 506 BED 1405 BED 1207 BED 807 BED 607 1401 1401 HÔTEL ROO **60 METRE HEIGHT LIMIT** LEVEL 7 62.800 47.300 31.800 22.100 3100 3100 3100 3100 3100 3100 3100 0016 / 3100 3100 3100 3100 3100 3100 3300 3300 ADDITIONAL INFORMATION

DISCLAIMER
Subject to: full site survey, measurements are preliminary, discussions and meetings with authorities, approval from authorities, relevant consultant information as per council DA requirements. Feasibility completed based on information provided by client.
Drawings are not are not suitable for purchase of property.
All parkings and ramps to traffic engineers details. (Subject to Approval)

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REF.	DATE	AMENDMENT	Т
Q	02.12.2021	DA SUBMISSION	-
T	24.06.2022	CLIENT REVIEW	-
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w	19.07.2022	ADDITIONAL INFORMATION	-
Y	18.11.2022	PRELIMINARY	┙
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Sydney Level 10, 6 Mount Olympus Boulevard, Wolli Creek NSW 2205 Nominated Architect: Robert Gizzi (Reg. 8286)

DRAWING NAME: SECTION A

CLIENT: 24-30 KENNY STREET, WOLLONGONG, NSW ADDRESS:

ANYA SOLUTION Pty Ltd MIXED USE DEVELOPMENT SCALE BAR: PROJECT No. ISSUE DATE: 28.11.2022 2289 DRAWN: NT/SL DWG No. Rev. SCALE: 1:250

12.5m


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All parking	g and ramps to traffi	c engineers details. (Subject to Appro	ovai)
REF.	DATE	AMENDMENT	
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Т	24.06.2022	CLIENT REVIEW	
U	04.07.2022	ADDITIONAL INFORMATION	
W	19.07.2022	ADDITIONAL INFORMATION	
Y	18.11.2022	PRELIMINARY	
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Sydney Level 10, 6 Mount Olympus Boulevard, Wolli Creek NSW 2205 Nominated Architect: Robert Gizzi (Reg. 8286)

DRAWING NAME: SECTION B

CLIENT: ADDRESS:

ANYA SOLUTION Pty Ltd MIXED USE DEVELOPMENT 24-30 KENNY STREET, WOLLONGONG, NSW

SCALE BAR: 5 7.5 10 12.5m

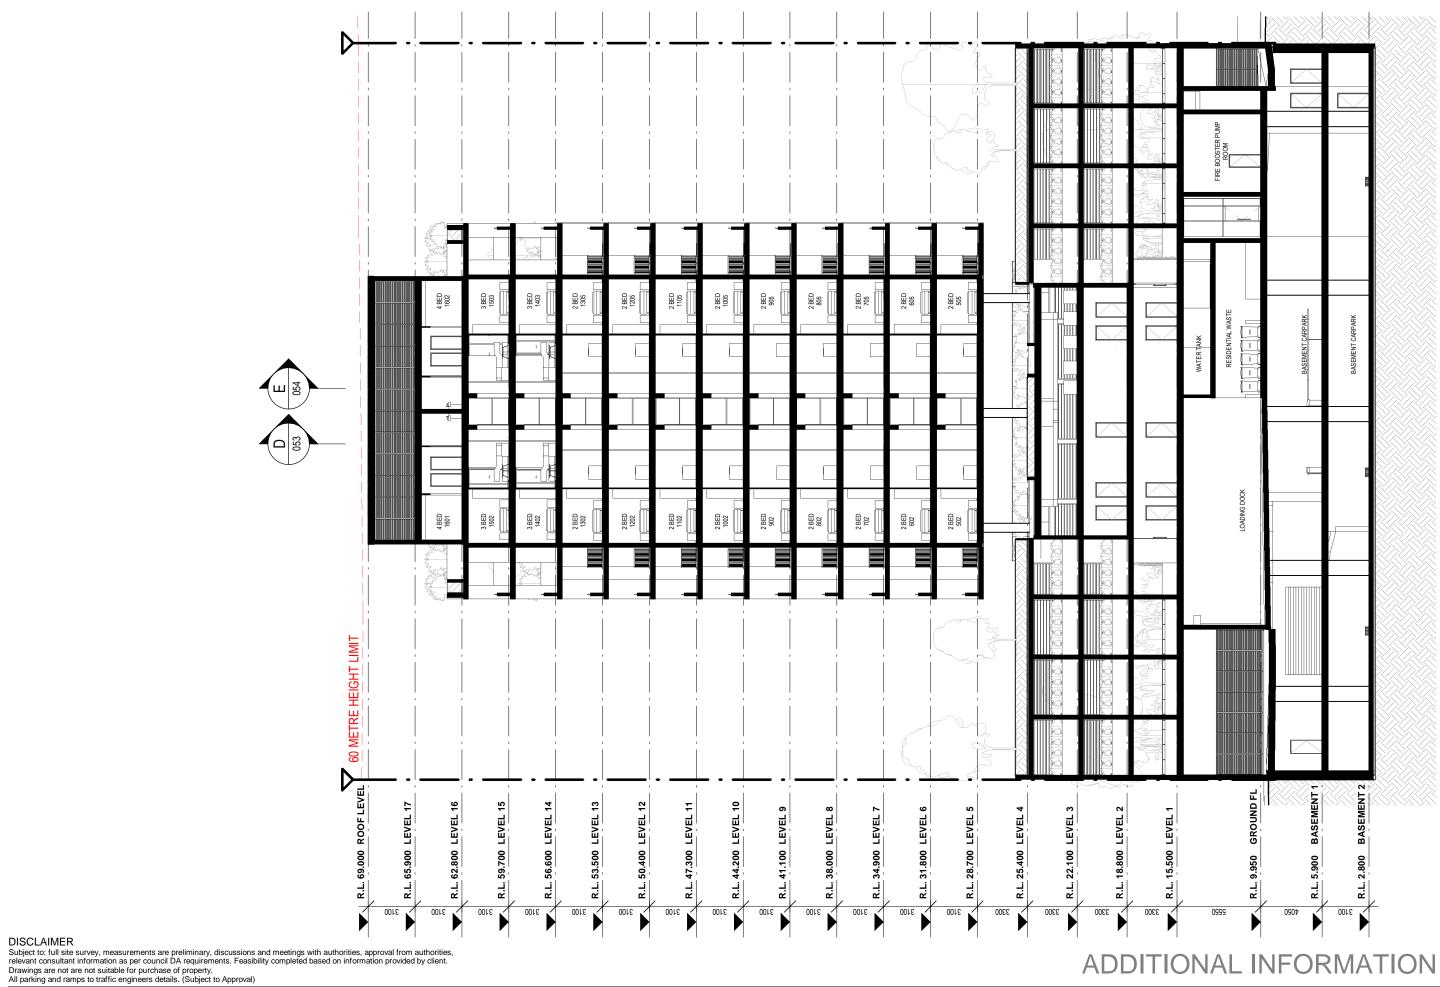ISSUE DATE: PROJECT No. 28.11.2022 2289 DRAWN: NT/SL DWG No. Rev. SCALE: 1:250 051 ВВ QA: RG



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W	19.07.2022	ADDITIONAL INFORMATION	
Y	18.11.2022	PRELIMINARY	
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neters. Verify all dimensions on site prior to commencement of any work

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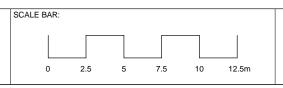
Wollongong 81a Princes Highway, Fairy Meadow NSW 2519 Tel: (02) 4227 1661 Email: info@designworkshop.com.au Web: www.designworkshop.com.au

Sydney Level 10, 6 Mount Olympus Boulevard, Wolli Creek NSW 2205 Nominated Architect: Robert Gizzi (Reg. 8286)

DRAWING NAME: SECTION C

CLIENT: ADDRESS:


ANYA SOLUTION Pty Ltd MIXED USE DEVELOPMENT 24-30 KENNY STREET, WOLLONGONG, NSW



ISSUE DATE: PROJECT No. 28.11.2022 2289 DRAWN: NT/SL DWG No. Rev. SCALE: 1:250

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W	19.07.2022	ADDITIONAL INFORMATION
Y	18.11.2022	PRELIMINARY
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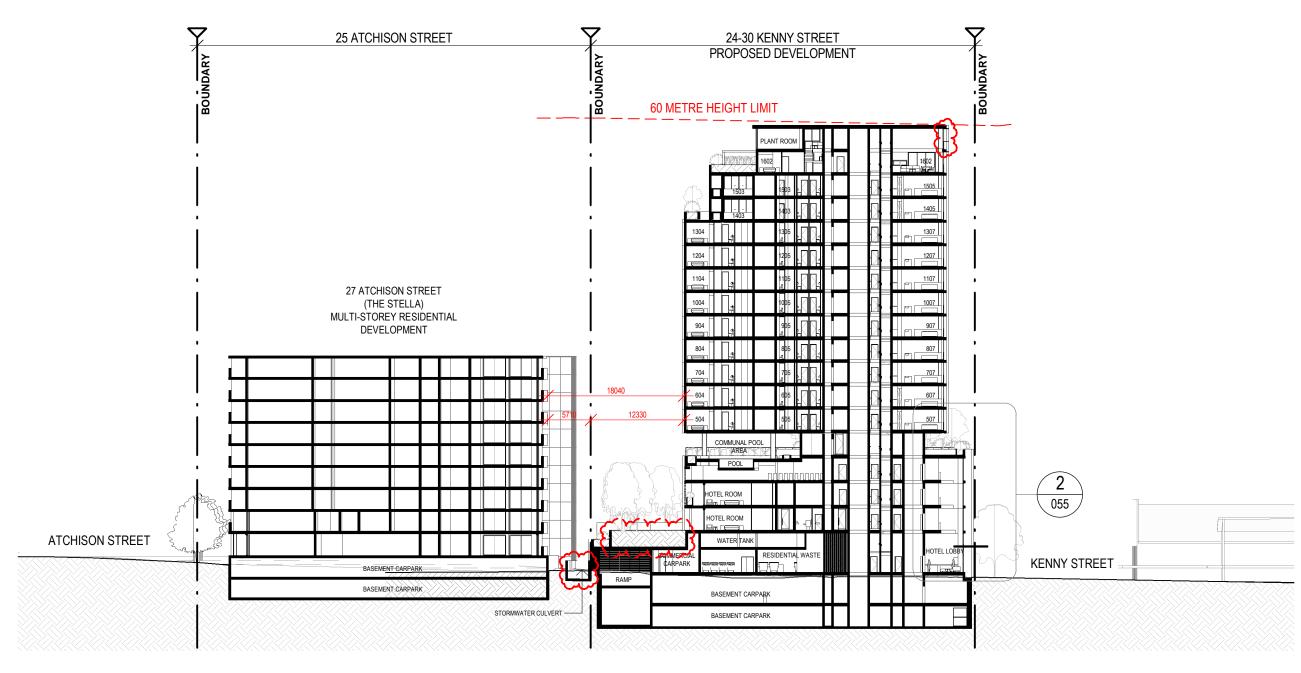
Sydney Level 10, 6 Mount Olympus Boulevard, Wolli Creek NSW 2205 Nominated Architect: Robert Gizzi (Reg. 8286)

DRAWING NAME: SECTION D

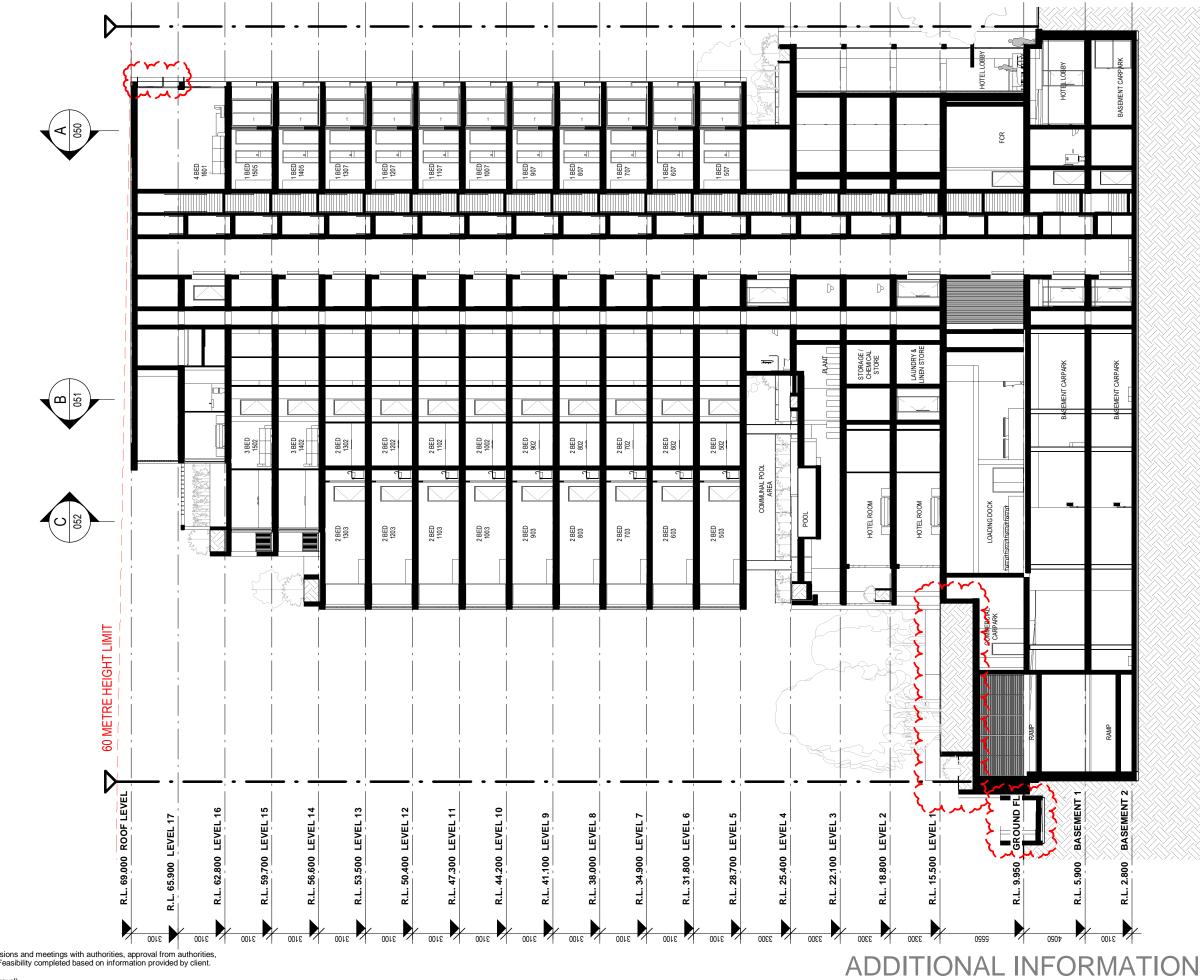ANYA SOLUTION Pty Ltd MIXED USE DEVELOPMENT CLIENT: 24-30 KENNY STREET, WOLLONGONG, NSW ADDRESS:

SCALE BAR: 0 2.5 5 7.5 10 12.5m

ISSUE DATE: PROJECT No. 28.11.2022 2289 DRAWN: NT/SL DWG No. Rev. SCALE: 1:250 053 ВВ QA: RG



SITE SECTION E-E

DISCLAIMER
Subject to: full site survey, measurements are preliminary, discussions and meetings with authorities, approval from authorities, relevant consultant information as per council DA requirements. Feasibility completed based on information provided by client.

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an parking	and ramps to train	c engineers details. (Subject to Appr	ovai)
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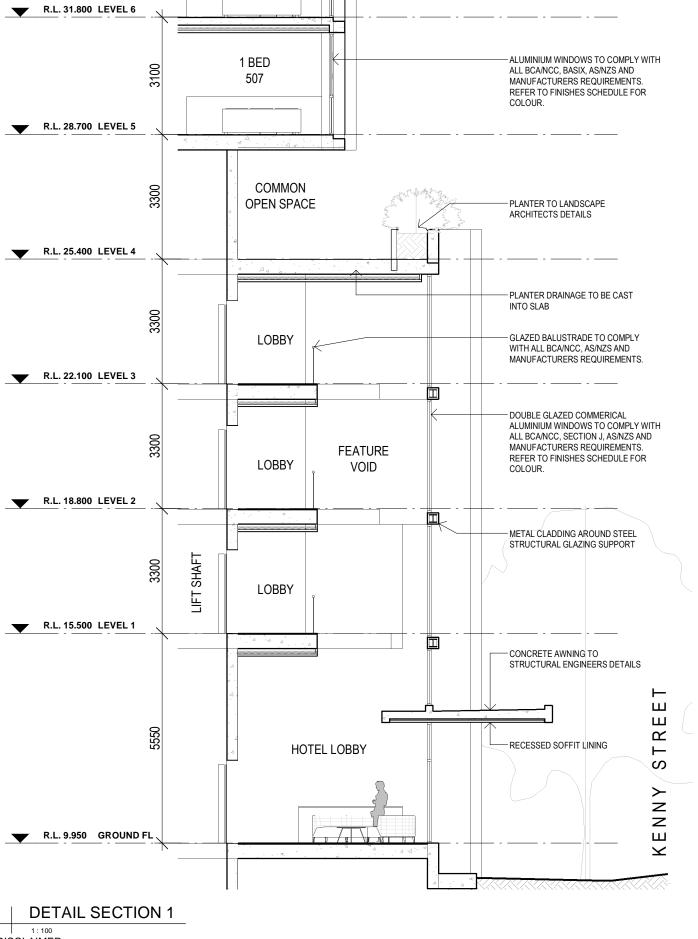
Wollongong 81a Princes Highway, Fairy Meadow NSW 2519 Tel: (02) 4227 1661 Email: info@designworkshop.com.au IA Web: www.designworkshop.com.au

Sydney Level 10, 6 Mount Olympus Boulevard, Wolli Creek NSW 2205 Nominated Architect: Robert Gizzi (Reg. 8286) DRAWING NAME: SITE SECTION E

ANYA SOLUTION Pty Ltd MIXED USE DEVELOPMENT CLIENT: 24-30 KENNY STREET, WOLLONGONG, NSW ADDRESS:

ADDITIONAL INFORMATION SCALE BAR: 10 15 20

PROJECT No. ISSUE DATE: 28.11.2022 2289 DRAWN: NT / AK DWG No. Rev. SCALE: 1:500 054 ВВ QA: RG



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ADDITIONAL INFORMATION 25.11.2022 28.11.2022 04.07.2022 19.07.2022 ADDITIONAL INFORMATION millimeters. Verify all dimensions on site prior to commencement of any work

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Sydney Level 10, 6 Mount Olympus Boulevard, Wolli Creek NSW 2205 Nominated Architect: Web: www.designworkshop.com.au Robert Gizzi (Reg. 8286)

CLIENT:

DRAWING NAME: DETAIL SECTIONS

ANYA SOLUTION Pty Ltd MIXED USE DEVELOPMENT 24-30 KENNY STREET, WOLLONGONG, NSW

R.L. 31.800 LEVEL 6

R.L. 28.700 LEVEL 5

R.L. 25.400 LEVEL 4

R.L. 22.100 LEVEL 3

R.L. 18.800 LEVEL 2

R.L. 15.500 LEVEL 1

R.L. 9.950 GROUND FL

DETAIL SECTION 2

1:100

3300

3300

2 BED

506

COMMUNAL OPEN

SPACE

HOTEL ROOM

HOTEL ROOM

HOTEL ROOM

HOTEL LOBBY

SCALE BAR: 2 3 ISSUE DATE: 28.11.2022 PROJECT No. 2289 DRAWN: NT/SL SCALE: 1:100 DWG No. Rev

QA: RG

ALUMINIUM WINDOWS TO COMPLY WITH

ALL BCA/NCC, BASIX, AS/NZS AND MANUFACTURERS REQUIREMENTS. REFER TO FINISHES SCHEDULE FOR

PLANTER TO LANDSCAPE

OPERABLE FACADE LOUVRES TO COMPLY WITH ALL BCAINCC, BASIX, AS/NZS AND

MANUFACTURERS REQUIREMENTS.

REFER TO FINISHES SCHEDULE FOR

BALCONY DRAINAGE TO BE CAST

- GLAZED BALUSTRADE TO COMPLY WITH ALL BCA/NCC, AS/NZS AND MANUFACTURERS REQUIREMENTS.

FEATURE FACADE FINS. REFER TO PLANS AND ELEVATIONS FOR LOCATION / EXTENT

AND FINISHES SCHEDULE FOR COLOUR.

CONCRETE AWNING TO STRUCTURAL ENGINEERS DETAILS

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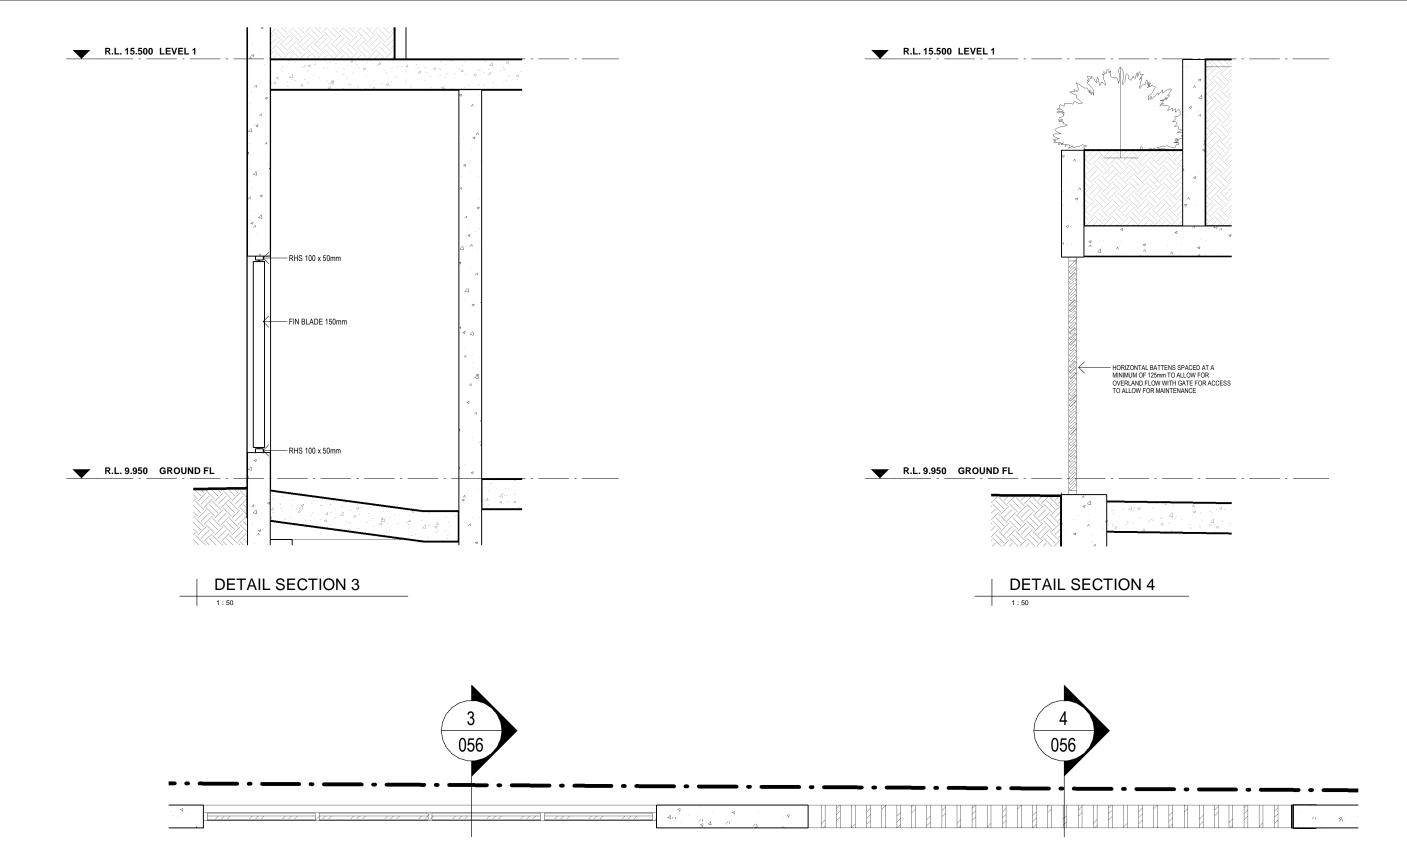
BALCONY

BALCONY

BALCONY

ADDITIONAL INFORMATION

055



DETAIL SECTION - GROUND FLOOR

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ADDITIONAL INFORMATION REF. BB 28.11.2022 DISCLAIMER
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DESIGN WORKSHOP AUSTRALIA

Wollongong 81a Princes Highway, Fairy Meadow NSW 2519 Tel: (02) 4227 1661 Email: info@designworkshop.com.au Web: www.designworkshop.com.au

Sydney Level 10, 6 Mount Olympus Boulevard, Wolli Creek NSW 2205 Nominated Architect: Robert Gizzi (Reg. 8286) DRAWING NAME: DETAIL SECTIONS

CLIENT: ADDRESS:

ANYA SOLUTION Pty Ltd MIXED USE DEVELOPMENT 24-30 KENNY STREET, WOLLONGONG, NSW

ADDITIONAL INFORMATION ISSUE DATE:

PROJECT No. 2289 DWG No. Rev. SCALE: 056 ВВ



















Subject to: full site survey, measurements are preliminary, discussions and meetings with authorities, approval from authorities, relevant consultant information as per council DA requirements. Feasibility completed based on information provided by client.

ADDITIONAL INFORMATION
All parking and ramps to surifice engineers details. (Subject to Approval)

DATE 06.09.2021

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CONSULTANT ISSUE
CONSULTANT ISSUE
DA SUBMISSION 04.11.2021 02.12.2021 ADDITIONAL INFORMATION 04.07.2022

W 19.07.2022 ADDITIONAL INFORMATION

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Sydney Level 10, 6 Mount Olympus Boulevard, Wolli Creek NSW 2205 Nominated Architect: Web: www.designworkshop.com.au Robert Gizzi (Reg. 8286)

ANYA SOLUTION Pty Ltd MIXED USE DEVELOPMENT CLIENT: ADDRESS:

24-30 KENNY STREET, WOLLONGONG, NSW

DRAWING NAME: 3D VIEWS

ISSUE DATE: PROJECT No. 28.11.2022 2289 DRAWN: AK DWG No. Rev. SCALE: 060 ВВ QA: RG





AMENDMENT
DA SUBMISSION
CLIENT ISSUE
CLIENT REVIEW
ADDITIONAL INFORMATION DATE 02.12.2021 27.04.2022 24.06.2022 04.07.2022

Wollongong 81a Princes Highway, Fairy Meadow NSW 2519

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Sydney Level 10, 6 Mount Olympus Boulevard, Wolli Creek NSW 2205 Nominated Architect: Robert Gizzi (Reg. 8286)

CLIENT: ADDRESS:

ANYA SOLUTION Pty Ltd MIXED USE DEVELOPMENT

DRAWING NAME: 3D PERSPECTIVE (FRONT)

24-30 KENNY STREET, WOLLONGONG, NSW

ADDITIONAL INFORMATION

ISSUE DATE: 28.11.2022 PROJECT No. 2289 DRAWN: AK DWG No. Rev. SCALE: ВВ 061 QA: RG





AMENDMENT
CONSULTANT ISSUE
DA SUBMISSION
CLIENT REVIEW DATE 04.11.2021 02.12.2021 24.06.2022 ADDITIONAL INFORMATION 04.07.2022

Wollongong 81a Princes Highway, Fairy Meadow NSW 2519 Email: info@designworkshop.com.au

Sydney Level 10, 6 Mount Olympus Boulevard, Wolli Creek NSW 2205 Nominated Architect: Web: www.designworkshop.com.au Robert Gizzi (Reg. 8286)

CLIENT:

ANYA SOLUTION Pty Ltd MIXED USE DEVELOPMENT

DRAWING NAME: 3D PERSPECTIVE (REAR)

24-30 KENNY STREET, WOLLONGONG, NSW


ADDITIONAL INFORMATION ISSUE DATE: 28.11.2022 PROJECT No. 2289

DRAWN: AK SCALE: QA: RG

DWG No. Rev.

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AMENDMENT
DA SUBMISSION
CLIENT REVIEW
ADDITIONAL INFORMATION
ADDITIONAL INFORMATION DATE 02.12.2021 24.06.2022 04.07.2022 19.07.2022

Wollongong 81a Princes Highway, Fairy Meadow NSW 2519 Tel: (02) 4227 1661

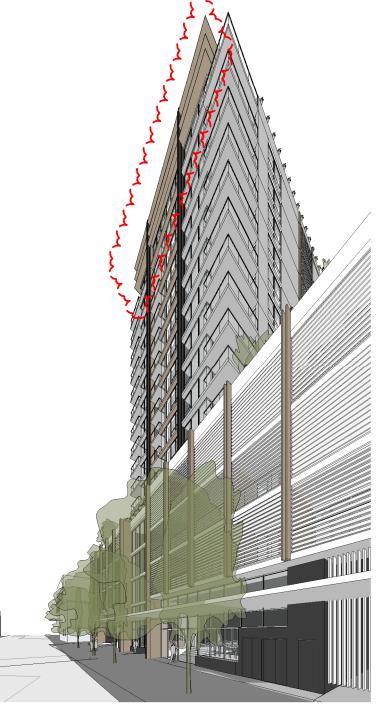Email: info@designworkshop.com.au Nominated Architect: Web: www.designworkshop.com.au Robert Gizzi (Reg. 8286)

Level 10, 6 Mount Olympus Boulevard, Wolli Creek NSW 2205

Sydney


ANYA SOLUTION Pty Ltd MIXED USE DEVELOPMENT CLIENT: ADDRESS:

24-30 KENNY STREET, WOLLONGONG, NSW DRAWING NAME: 3D PERSPECTIVES

ADDITIONAL INFORMATION

ISSUE DATE: PROJECT No. 28.11.2022 2289 DRAWN: AK DWG No. Rev. SCALE: ВВ 063 QA: RG



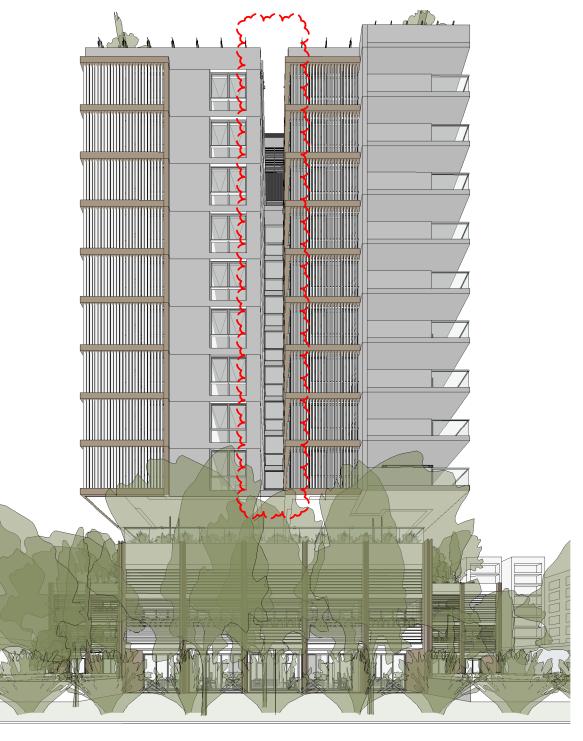



AMENDMENT
CONSULTANT ISSUE
DA SUBMISSION
CLIENT REVIEW DATE 04.11.2021 02.12.2021 24.06.2022 04.07.2022 ADDITIONAL INFORMATION ment of any work DESIGN WORKSHOP AUSTRALIA

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Sydney Level 10, 6 Mount Olympus Boulevard, Wolli Creek NSW 2205 Nominated Architect: Robert Gizzi (Reg. 8286)

CLIENT:

ANYA SOLUTION Pty Ltd MIXED USE DEVELOPMENT ADDRESS:


DRAWING NAME: 3D PERSPECTIVES

24-30 KENNY STREET, WOLLONGONG, NSW

ADDITIONAL INFORMATION

ISSUE DATE: PROJECT No. 2289 DRAWN: AK DWG No. Rev. SCALE: 064 ВВ QA: RG



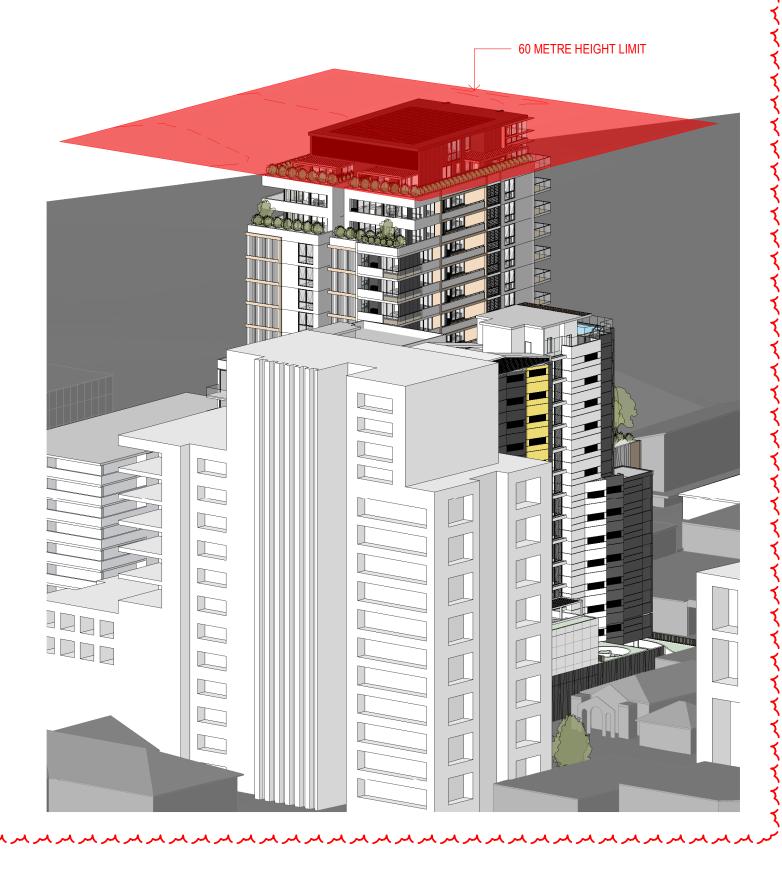

AMENDMENT CONSULTANT ISSUE 04.11.2021 DA SUBMISSION CLIENT REVIEW 02.12.2021 24.06.2022 ADDITIONAL INFORMATION 04.07.2022

Wollongong 81a Princes Highway, Fairy Meadow NSW 2519

Tel: (02) 4227 1661 Email: info@designworkshop.com.au Web: www.designworkshop.com.au Sydney Level 10, 6 Mount Olympus Boulevard, Wolli Creek NSW 2205 Nominated Architect: Robert Gizzi (Reg. 8286)

ANYA SOLUTION Pty Ltd MIXED USE DEVELOPMENT CLIENT: ADDRESS:

24-30 KENNY STREET, WOLLONGONG, NSW

DRAWING NAME: 3D PERSPECTIVE (HEIGHT PLANE)

ADDITIONAL INFORMATION

PROJECT No. ISSUE DATE: 28.11.2022 2289 DRAWN: NT/SL DWG No. Rev. SCALE: 065 BB QA: RG



AMENDMENT
CONSULTANT ISSUE
DA SUBMISSION
CLIENT REVIEW DATE 04.11.2021 02.12.2021 24.06.2022 04.07.2022 ADDITIONAL INFORMATION

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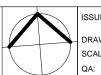
CLIENT: ADDRESS:

ANYA SOLUTION Pty Ltd MIXED USE DEVELOPMENT

DRAWING NAME: SHADOWS - WINTER


24-30 KENNY STREET, WOLLONGONG, NSW

ADDITIONAL INFORMATION




ISSUE DATE: 28.11.2022 SCALE:

PROJECT No. 2289 DWG No. Rev. 070 ВВ

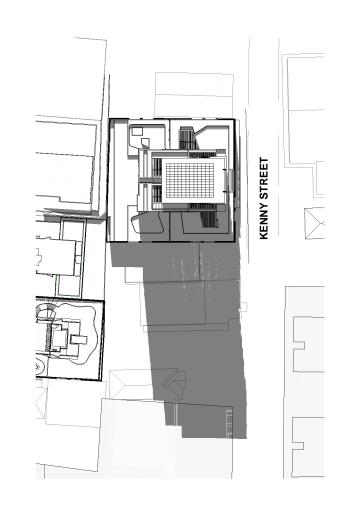



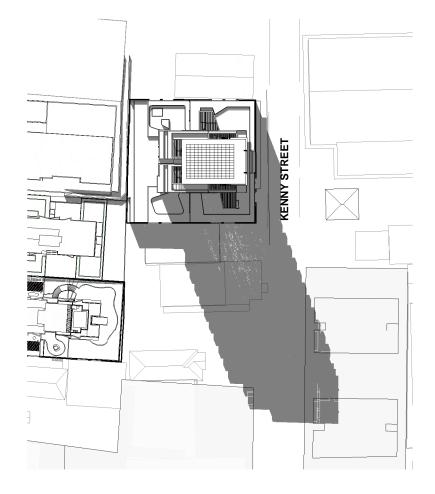

SHADOW PLAN - WINTER - 1.00pm



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Web: www.designworkshop.com.au

Sydney Level 10, 6 Mount Olympus Boulevard, Wolli Creek NSW 2205 Nominated Architect: Robert Gizzi (Reg. 8286)

CLIENT: ADDRESS:

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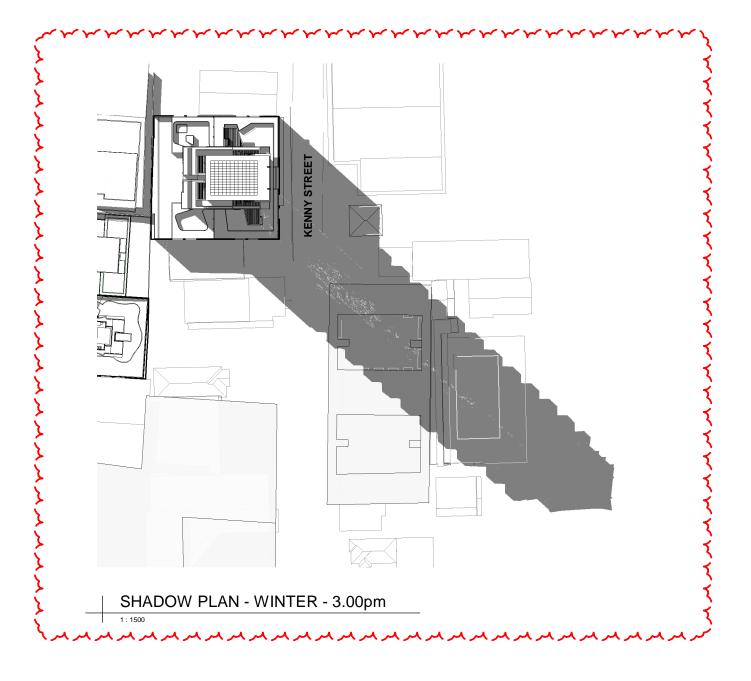
24-30 KENNY STREET, WOLLONGONG, NSW DRAWING NAME: SHADOWS - WINTER

ADDITIONAL INFORMATION PROJECT No.



ISSUE DATE: 28.11.2022 SCALE: QA:

2289 DWG No. Rev. 071 ВВ



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CONSULTANT ISSUE
DA SUBMISSION
CLIENT REVIEW DATE 04.11.2021 02.12.2021 24.06.2022 04.07.2022 ADDITIONAL INFORMATION

Wollongong 81a Princes Highway, Fairy Meadow NSW 2519 Tel: (02) 4227 1661


Email: info@designworkshop.com.au Web: www.designworkshop.com.au

Sydney Level 10, 6 Mount Olympus Boulevard, Wolli Creek NSW 2205 Nominated Architect: Robert Gizzi (Reg. 8286) DRAWING NAME: SHADOWS - WINTER


CLIENT: ADDRESS:

ANYA SOLUTION Pty Ltd MIXED USE DEVELOPMENT 24-30 KENNY STREET, WOLLONGONG, NSW

ADDITIONAL INFORMATION ISSUE DATE: PROJECT No.

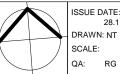

28.11.2022 2289 DWG No. Rev. SCALE: 072 ВВ

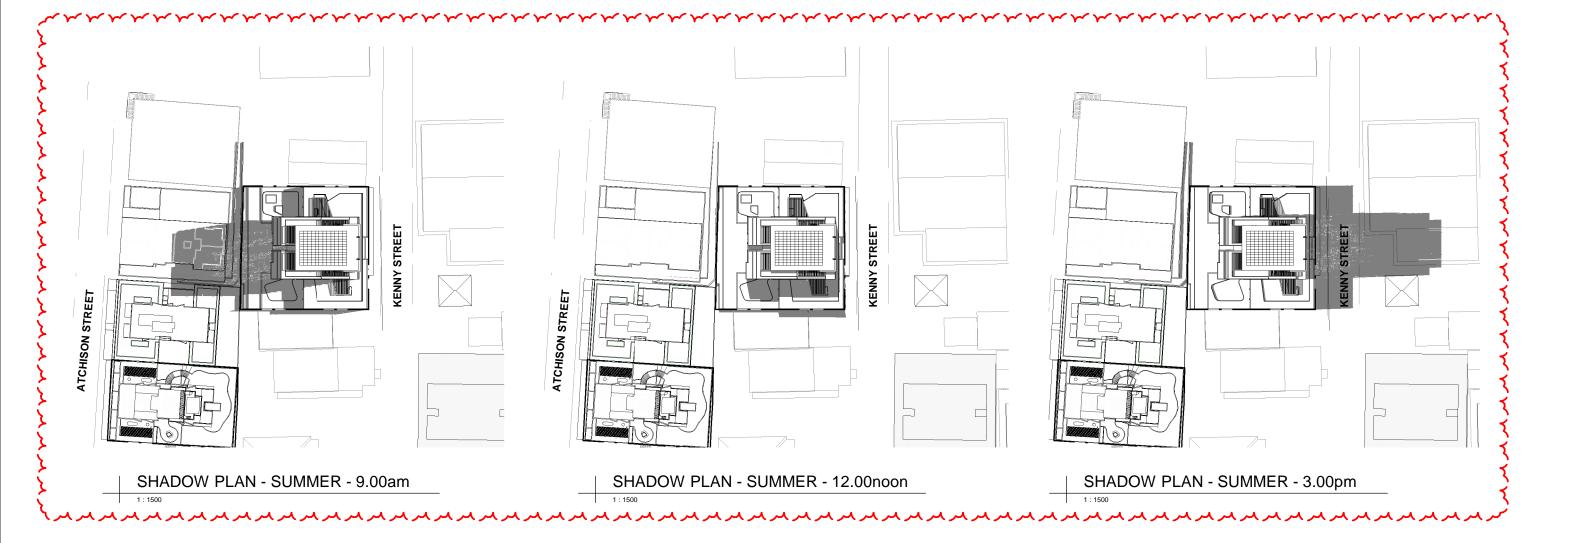

AMENDMENT
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Web: www.designworkshop.com.au

Sydney Level 10, 6 Mount Olympus Boulevard, Wolli Creek NSW 2205 Nominated Architect: Robert Gizzi (Reg. 8286)

CLIENT:


ANYA SOLUTION Pty Ltd MIXED USE DEVELOPMENT


24-30 KENNY STREET, WOLLONGONG, NSW DRAWING NAME: SHADOWS - SUMMER

ADDITIONAL INFORMATION





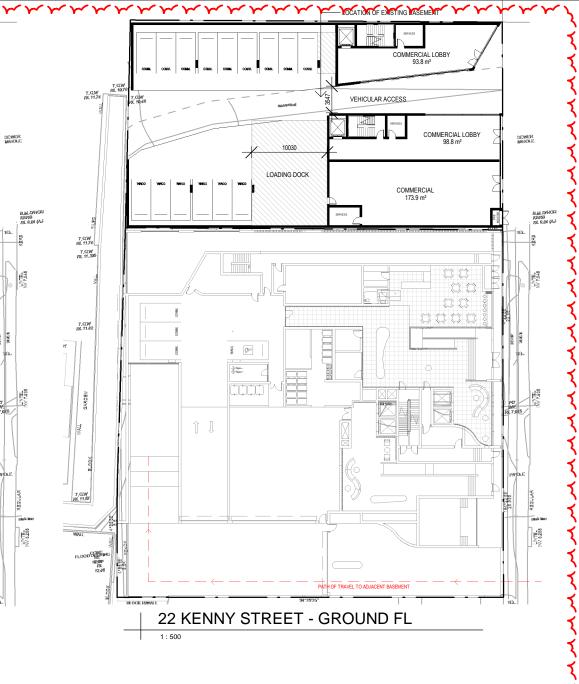

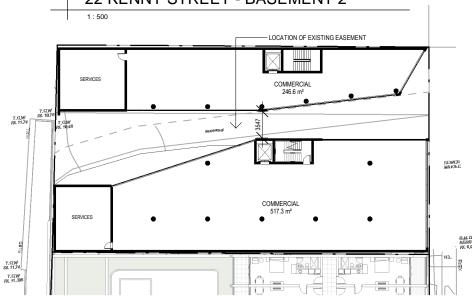

AMENDMENT CLIENT REVIEW DATE 24.06.2022 04.07.2022 13.07.2022 ADDITIONAL INFORMATION PRELIMINARY ADD INFO ADDITIONAL INFORMATION 19.07.2022

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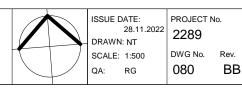
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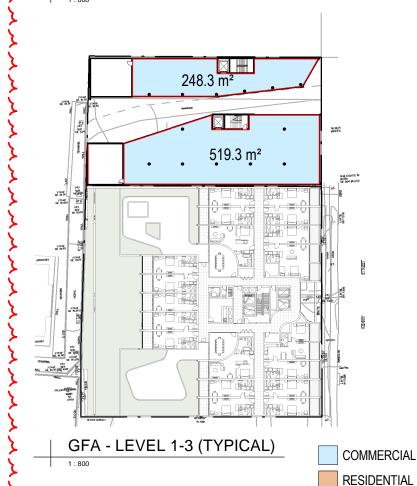
24-30 KENNY STREET, WOLLONGONG, NSW DRAWING NAME: ADJACENT DEVELOPMENT ANALYSIS (COMM) SCALE BAR:

ADDITIONAL INFORMATION

20



93.8 m² 279.4 m² 10.00 (ELLIP) VONE VONE VONE VONE V.O. M.DE GFA - GROUND FLOOR



ADJACENT LOT (OPTION A) GFA SCHEDULE

LEVEL	AREA TYPE	AREA	FSR
GROUND FL	COMMERCIAL	373.22 m ²	0.27
LEVEL 1	COMMERCIAL	767.58 m ²	0.56
LEVEL 2	COMMERCIAL	767.58 m ²	0.56
LEVEL 3	COMMERCIAL	767.58 m ²	0.56
		2675 Q5 m ²	1 07

22 KENNY STREET - PARKING SCHEDULE

LEVEL	QTY	
COMMERCIAL PARKING		
BASEMENT 2	16	

16 15

47

47

TOTAL NO. CAR SPACES


BASEMENT 1

GROUND FL

FSR / GFA CALCULATIONS & FORMULAS APPROX SITE AREA = 1359m²

Site Area	1359			
X	0.46583			
	Area	%		Total Area
Non Res (NRFSR)	2675.95	100.00		2675.95
Res (RFSR)	0	0.00		
	RFSR =	2.69875	(2 + 1.5 x X)	
	NRFSR =	4.664583333	(3.5 + 2.5 x X)
(NRFSR x NR / 100)	+	(RFSR x R / 100)	:1	
4.665	+	0.000	:1	
Allowable FSR	4.66 :1			
Allowable GFA	6339.2			
Proposed FSR	1.97 :1			

3663.2

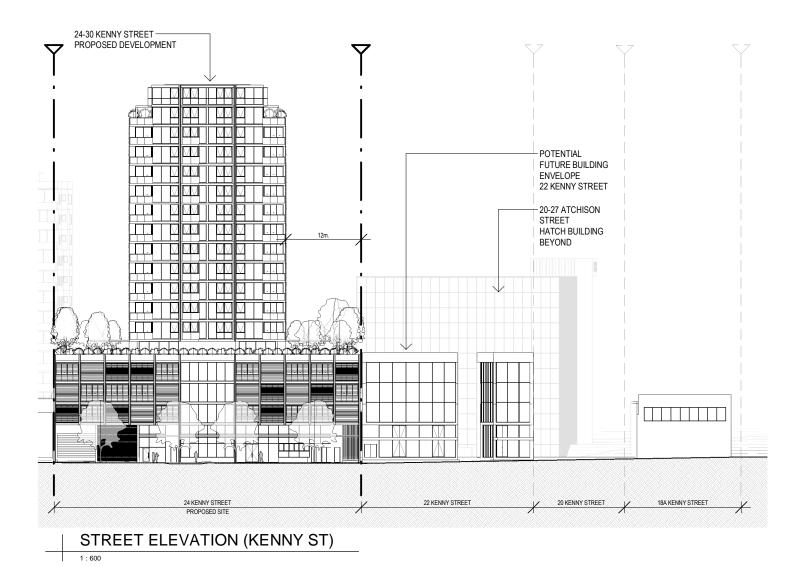

Area Difference

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V	13.07.2022	PRELIMINARY ADD INFO	
w	19.07.2022	ADDITIONAL INFORMATION	
Y	18.11.2022	PRELIMINARY	
DISCLAIN All dimensions	MER are in millimeters. Verify all d	dimensions on site prior to commencement of any work.	DESIGN

Wollongong 81a Princes Highway, Fairy Meadow NSW 2519 Tel: (02) 4227 1661 Email: info@designworkshop.com.au


Web: www.designworkshop.com.au

Sydney Level 10, 6 Mount Olympus Boulevard, Wolli Creek NSW 2205 Nominated Architect: Robert Gizzi (Reg. 8286)

ANYA SOLUTION Pty Ltd MIXED USE DEVELOPMENT CLIENT: ADDRESS:

24-30 KENNY STREET, WOLLONGONG, NSW DRAWING NAME: ADJACENT DEVELOPMENT ANALYSIS (COMM)

ADDITIONAL INFORMATION

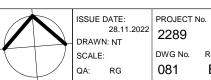

Rev.




ADJACENT DEVELOPMENT - SHADOW - WINTER - 9.00am

KENNY STREET ATCHISON STREET


ADJACENT DEVELOPMENT - SHADOW - WINTER - 10.30am



ADJACENT DEVELOPMENT - SHADOW - WINTER - 9.30am

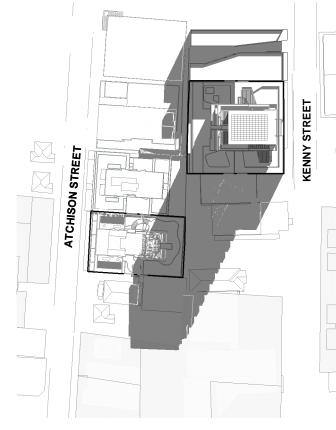

ADJACENT DEVELOPMENT - SHADOW - WINTER - 10.00am

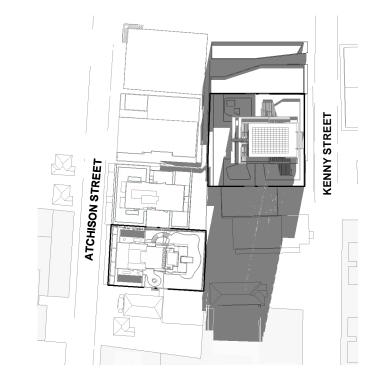

ADJACENT DEVELOPMENT - SHADOW - WINTER - 11.00am

KENNY STREET ATCHISON STREET

ADJACENT DEVELOPMENT - SHADOW - WINTER - 11.30am

Subject to: full site survey, measurements are preliminary, discussions and meetings with authorities, approval from authorities, relevant consultant information as per council DA requirements. Feasibility completed based on information provided by client. Drawings are not are not suitable for purchase of property.

All parking and ramps to traffic engineers details. (Subject to Approval)

REF. AA BB V W DATE 25.11.2022 28.11.2022 13.07.2022

AMENDMENT
ADDITIONAL INFORMATION
ADDITIONAL INFORMATION
PRELIMINARY ADD INFO ADDITIONAL INFORMATION 19.07.2022



Wollongong 81a Princes Highway, Fairy Meadow NSW 2519 Tel: (02) 4227 1661 Email: info@designworkshop.com.au

Sydney Level 10, 6 Mount Olympus Boulevard, Wolli Creek NSW 2205 Nominated Architect: Web: www.designworkshop.com.au Robert Gizzi (Reg. 8286)

CLIENT: ADDRESS:

ANYA SOLUTION Pty Ltd MIXED USE DEVELOPMENT

24-30 KENNY STREET, WOLLONGONG, NSW

DRAWING NAME: ADJACENT DEVELOPMENT ANALYSIS (SHADOWS)


ADDITIONAL INFORMATION




ISSUE DATE: 28.11.2022 SCALE:

QA:

PROJECT No. 2289 DWG No. Rev. 082 BB

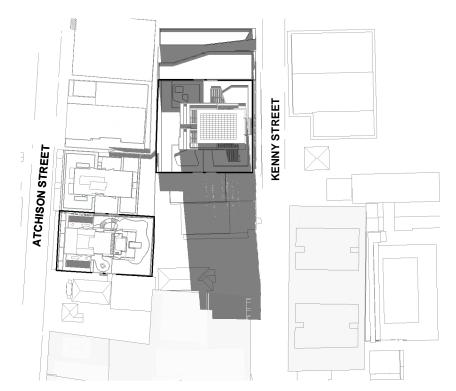

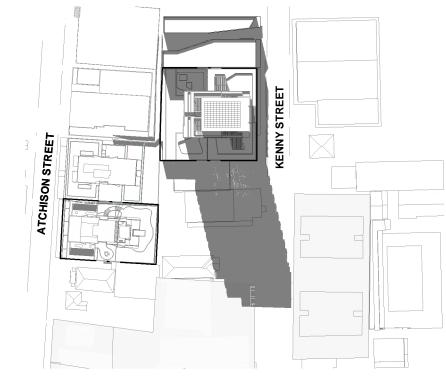



ATCHISON STREET


ADJACENT DEVELOPMENT - SHADOW - WINTER - 12.00noon

ADJACENT DEVELOPMENT - SHADOW - WINTER - 12.30pm 1:2000

ADJACENT DEVELOPMENT - SHADOW - WINTER - 1.00pm

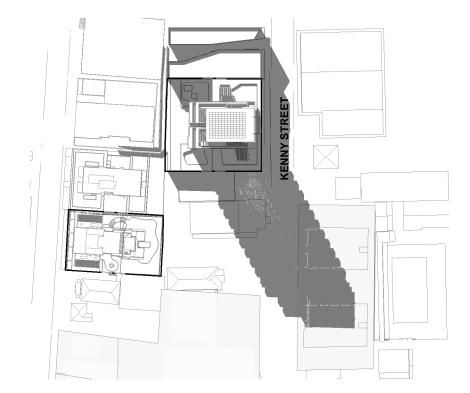

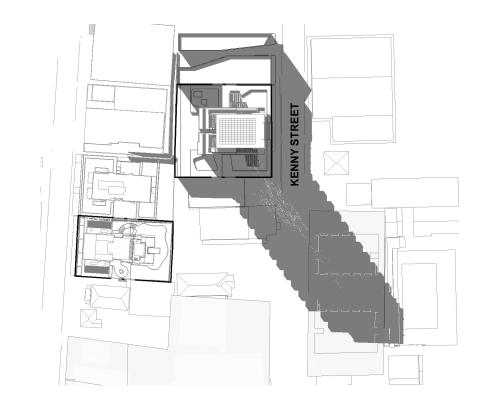

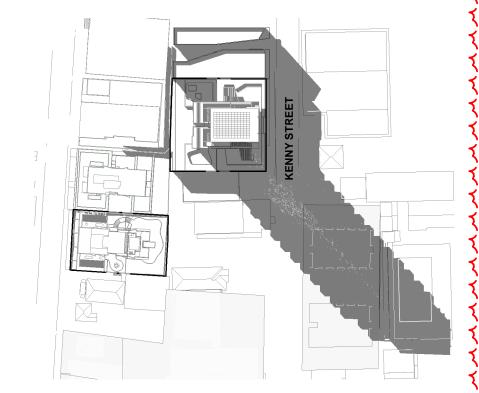

ADJACENT DEVELOPMENT - SHADOW - WINTER - 1.30pm

ADJACENT DEVELOPMENT - SHADOW - WINTER - 2.00pm

ADJACENT DEVELOPMENT - SHADOW - WINTER - 2.30pm

All parking	and ramps to train	c engineers details. (Odbject to App	novai)
REF.	DATE	AMENDMENT	
AA	25.11.2022	ADDITIONAL INFORMATION	
BB	28.11.2022	ADDITIONAL INFORMATION	
V	13.07.2022	PRELIMINARY ADD INFO	
W	19.07.2022	ADDITIONAL INFORMATION	
Υ	18.11.2022	PRELIMINARY	
DISCLAIN All dimensions a		limensions on site prior to commencement of any wor	DESIGN WORKSH

SHOP AUSTRALIA

Wollongong 81a Princes Highway, Fairy Meadow NSW 2519 Tel: (02) 4227 1661 Email: info@designworkshop.com.au Web: www.designworkshop.com.au Sydney Level 10, 6 Mount Olympus Boulevard, Wolli Creek NSW 2205 Nominated Architect: Robert Gizzi (Reg. 8286) DRAWING NAME: ADJACENT DEVELOPMENT ANALYSIS (SHADOWS)

CLIENT: ADDRESS:

ANYA SOLUTION Pty Ltd MIXED USE DEVELOPMENT

24-30 KENNY STREET, WOLLONGONG, NSW

ADDITIONAL INFORMATION



ISSUE DATE: 28.11.2022 SCALE:

PROJECT No. 2289 DWG No. Rev. 083 BB



AMENDMENT
ADDITIONAL INFORMATION
ADDITIONAL INFORMATION
PRELIMINARY ADD INFO
ADDITIONAL INFORMATION DATE 25.11.2022 28.11.2022 13.07.2022 19.07.2022

cement of any work DESIGN WORKSHOP AUSTRALIA

Wollongong 81a Princes Highway, Fairy Meadow NSW 2519 Tel: (02) 4227 1661

Sydney Level 10, 6 Mount Olympus Boulevard, Wolli Creek NSW 2205 Email: info@designworkshop.com.au Nominated Architect: Web: www.designworkshop.com.au Robert Gizzi (Reg. 8286)

DRAWING NAME: ADJACENT DEVELOPMENT ANALYSIS (SHADOWS)

CLIENT: ADDRESS:

ANYA SOLUTION Pty Ltd MIXED USE DEVELOPMENT

24-30 KENNY STREET, WOLLONGONG, NSW

ADDITIONAL INFORMATION

ISSUE DATE: SCALE:

PROJECT No. 28.11.2022 2289 DWG No. 084 QA:

Rev.

COMMON OPEN SPACE SOLAR ANALYSIS

TOTAL SITE AREA: 2466.0m²

TOTAL COS REQUIRED: 616.5m² (25%) TOTAL COS PROVIDED: 852.0m² (34.5%)

362.04m² NOMINATED AREA OF PRINCIPAL USEABLE OPEN SPACE (NE ASPECT):

TOTAL AREA OF PRINCIPAL USEABLE OPEN SPACE TO ACHIEVE 2 HOURS OF SOLAR ACCESS (50% OF TOTAL AREA)

362.04m² x 0.5 =181.02m²

TOTAL AREA THAT ACHIEVES SOLAR ACCES (INDICATED IN PINK BELOW)

9:00am 253.39m² (69.9%) 9:30am 276.31m² (76.3%) 10:00am 285.06m² (78.7%) 10:30am 295.50m² (81.6%) 11:00am 306.20m² (84.5%)





RED HATCH INDICATES REQUIRED AREA TO COMPLY WITH COUNCIL REQUIREMENTS -616.5m² (25%)




TOTAL PRINCIPAL USEABLE COMMON OPEN SPACE AREA


TOTAL COMMON OPEN SPACE AREA

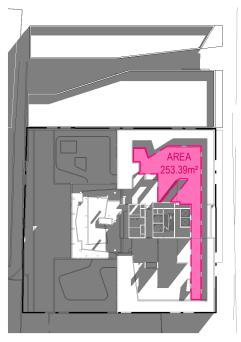


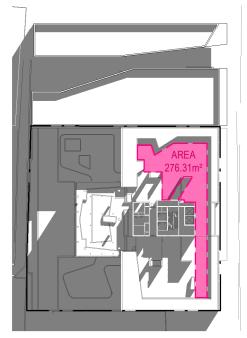

KENNY STREET

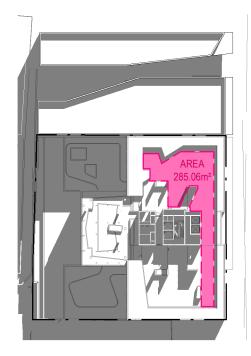

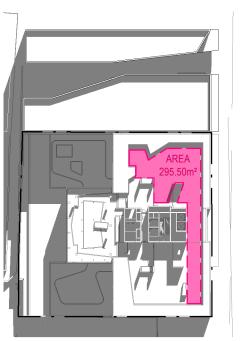

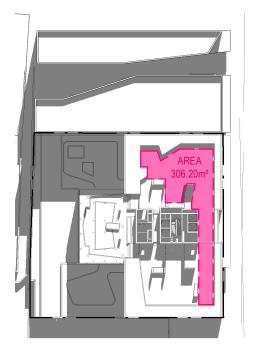

COS ANALYSIS - WINTER - 11.00am

COS ANALYSIS - WINTER - 9.00am

COS ANALYSIS - WINTER - 9.30am

COS ANALYSIS - WINTER - 10.00am

COS ANALYSIS - WINTER - 10.30am

NOTE: ALL SHADOW PLANS SHOW THE IMPACT OF THE ADJACENT FUTURE BUILDING ON THE PROPOSED LEVEL 4 COMMON OPEN SPACE

DISCLAIMER
Subject to: full site survey, measurements are preliminary, discussions and meetings with authorities, approval from authorities, relevant consultant information as per council DA requirements. Feasibility completed based on information provided by client.

Drawings are not are not suitable for purchase of property.

All parking and ramps to traffic engineers details. (Subject to Approval)

	3	3
RE	F. DATE	AMENDMENT
A	25.11.2022	ADDITIONAL INFORMATION
BI	3 28.11.2022	ADDITIONAL INFORMATION
V	13.07.2022	PRELIMINARY ADD INFO
V	19.07.2022	ADDITIONAL INFORMATION
Υ	18.11.2022	PRELIMINARY
DICC	LAIMED	

Wollongong 81a Princes Highway, Fairy Meadow NSW 2519 Tel: (02) 4227 1661 Email: info@designworkshop.com.au

Web: www.designworkshop.com.au

Sydney Level 10, 6 Mount Olympus Boulevard, Wolli Creek NSW 2205 Nominated Architect: Robert Gizzi (Reg. 8286)

CLIENT: ADDRESS: ANYA SOLUTION Pty Ltd MIXED USE DEVELOPMENT

DRAWING NAME: ADJACENT DEVELOPMENT ANALYSIS (COS)

24-30 KENNY STREET WOLLONGONG, NSW


ADDITIONAL INFORMATION




ISSUE DATE: 28.11.2022 SCALE:

QA:


PROJECT No. 2289 DWG No. Rev. 085 BB

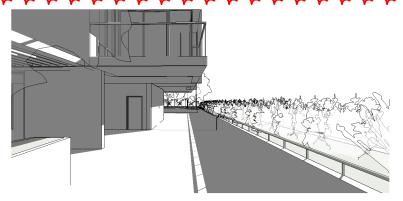


COS SOLAR ANALYSIS - VIEW 1 - WINTER 9am

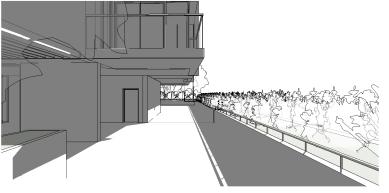


COS SOLAR ANALYSIS - VIEW 1 - WINTER 9.30am

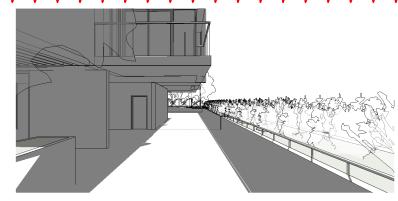


COS SOLAR ANALYSIS - VIEW 1 - WINTER 10am

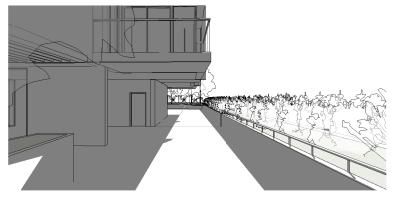


COS SOLAR ANALYSIS - VIEW 1 - WINTER 10.30am

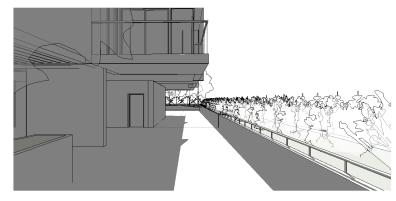


COS SOLAR ANALYSIS - VIEW 1 - WINTER 11am

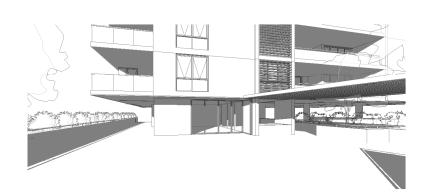


COS SOLAR ANALYSIS - VIEW 2 - WINTER 9am

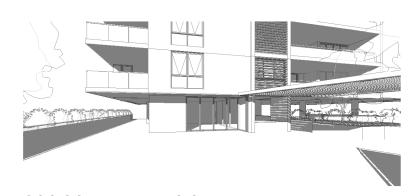


COS SOLAR ANALYSIS - VIEW 2 - WINTER 9.30am

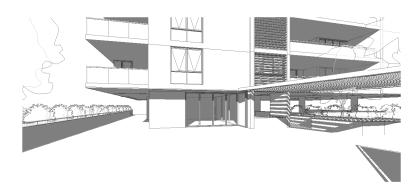

COS SOLAR ANALYSIS - VIEW 2 - WINTER 10am

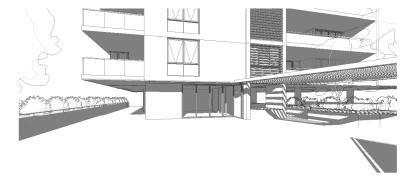

COS SOLAR ANALYSIS - VIEW 2 - WINTER 10.30am

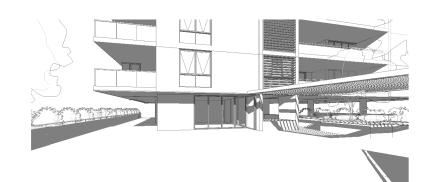

COS SOLAR ANALYSIS - VIEW 2 - WINTER 11am

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All parking and ramps to traffic engineers details. (Subject to Approval)

AMENDMENT
ADDITIONAL INFORMATION DATE 25.11.2022 28.11.2022 13.07.2022 ADDITIONAL INFORMATION PRELIMINARY ADD INFO 19.07.2022

ADDITIONAL INFORMATION



Wollongong 81a Princes Highway, Fairy Meadow NSW 2519 Tel: (02) 4227 1661 Email: info@designworkshop.com.au

Sydney Level 10, 6 Mount Olympus Boulevard, Wolli Creek NSW 2205 Nominated Architect: Robert Gizzi (Reg. 8286)

CLIENT: ADDRESS:

ANYA SOLUTION Pty Ltd MIXED USE DEVELOPMENT

24-30 KENNY STREET, WOLLONGONG, NSW

DRAWING NAME: ADJACENT DEVELOPMENT ANALYSIS (COS)


ADDITIONAL INFORMATION




ISSUE DATE:


PROJECT No. 28.11.2022 2289 DWG No. 086

Rev.

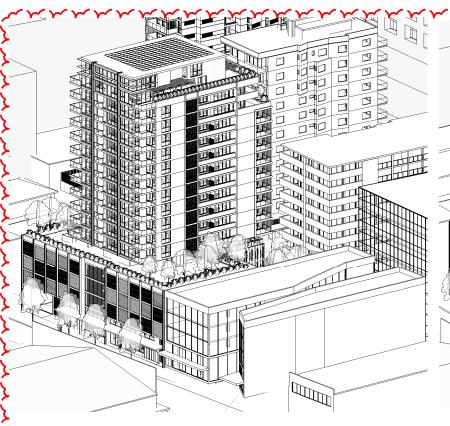




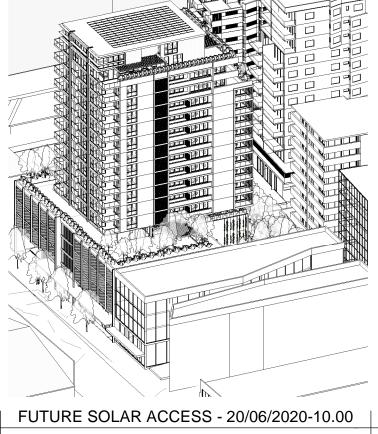

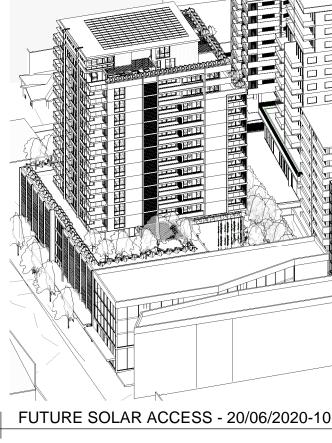

FUTURE SOLAR ACCESS - 20/06/2020-9.00


FUTURE SOLAR ACCESS - 20/06/2020-10.30

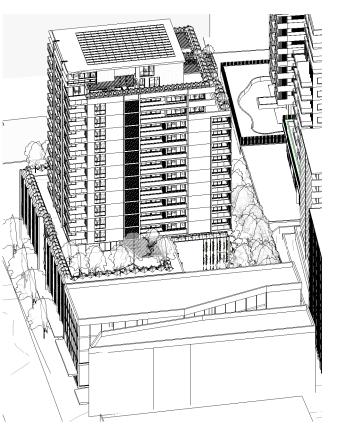






FUTURE SOLAR ACCESS - 20/06/2020-11.30

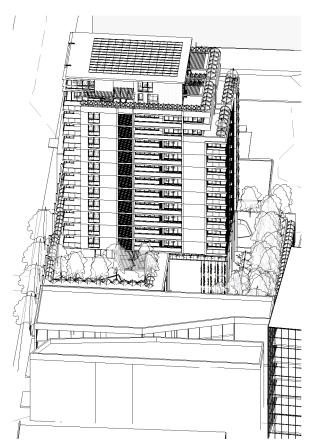

FUTURE SOLAR ACCESS - 20/06/2020-12.00

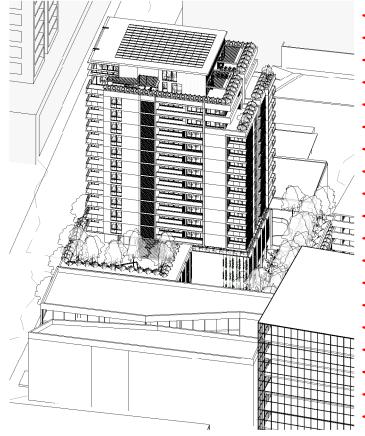

FUTURE SOLAR ACCESS - 20/06/2020-12.30

DISCLAIMER

Subject to: full site survey, measurements are preliminary, discussions and meetings with authorities, approval from authorities, relevant consultant information as per council DA requirements. Feasibility completed based on information provided by client. Drawings are not are not suitable for purchase of property. All parking and ramps to traffic engineers details. (Subject to Approval)

AMENDMENT CONSULTANT REVIEW 23.06.2022

24.06.2022 04.07.2022 CLIENT REVIEW
ADDITIONAL INFORMATION 13.07.2022 PRELIMINARY ADD INFO

Wollongong 81a Princes Highway Fairy Meadow NSW 2519 Tel: (02) 4227 1661

Sydney Level 10, 6 Mount Olympus Boulevard, Wolli Creek NSW 2205 Email: info@designworkshop.com.au Nominated Architect: Web: www.designworkshop.com.au Robert Gizzi (Reg. 8286)

CLIENT: ADDRESS:

ANYA SOLUTION Pty Ltd MIXED USE DEVELOPMENT


DRAWING NAME: ADJACENT DEVELOPMENT ANALYSIS (SOLAR)


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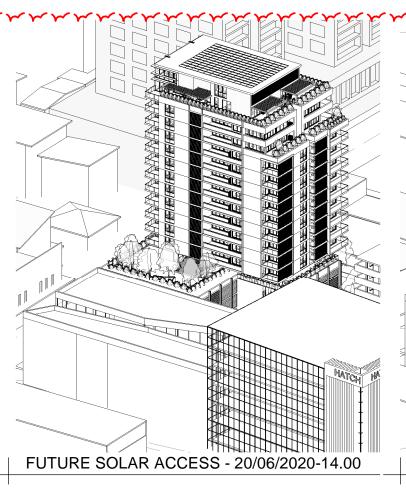
24-30 KENNY STREET, WOLLONGONG, NSW


ADDITIONAL INFORMATION


ISSUE DATE: PROJECT No. 28.11.2022 2289 DRAWN: NT DWG No. Rev 087 BB



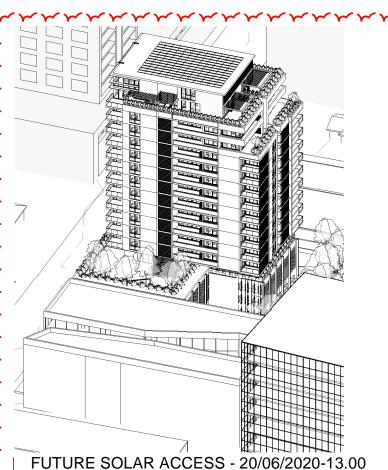

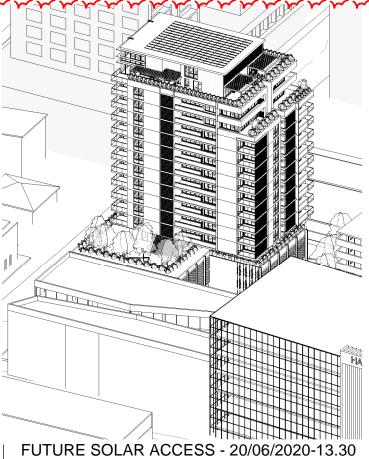

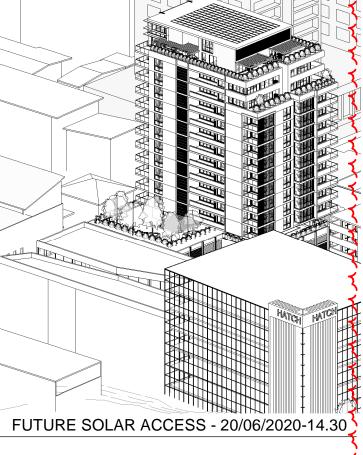

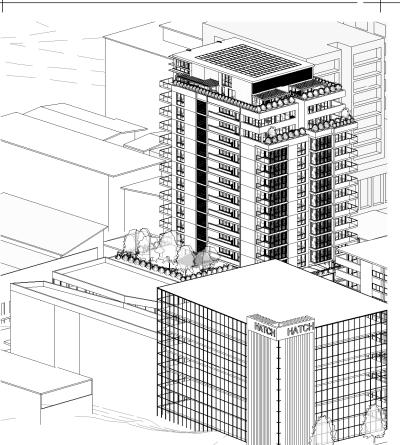

FUTURE SOLAR ACCESS - 20/06/2020-15.00

DISCLAIMER
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All parking and ramps to traffic engineers details. (Subject to Approval)

DATE 25.11.2022 28.11.2022 13.07.2022 19.07.2022 AMENDMENT
ADDITIONAL INFORMATION ADDITIONAL INFORMATION PRELIMINARY ADD INFO ADDITIONAL INFORMATION

Wollongong 81a Princes Highway, Fairy Meadow NSW 2519 Tel: (02) 4227 1661

Email: info@designworkshop.com.au Web: www.designworkshop.com.au Sydney Level 10, 6 Mount Olympus Boulevard, Wolli Creek NSW 2205 Nominated Architect: Robert Gizzi (Reg. 8286)

CLIENT: ADDRESS:

ANYA SOLUTION Pty Ltd MIXED USE DEVELOPMENT

24-30 KENNY STREET, WOLLONGONG, NSW

DRAWING NAME: ADJACENT DEVELOPMENT ANALYSIS (SOLAR)

ADDITIONAL INFORMATION



ISSUE DATE: 28.11.2022 SCALE:

PROJECT No. 2289 DWG No. Rev. 880 ВВ

FUTURE SOLAR COMPLIANCE (HALF-HOURLY)																			
UNIT NO.	UNIT TYPE	0900	0930	1000	1030	1100	1130	1200	1230	1300	1330	1400	1430	1500	TOTAL	2HRS	%	NIL HRS	% NIL HRS
501	2 BED	Yes	Yes	Yes	Yes	Yes	No	2.0	1	1.33%	0	0.00%							
502	2 BED	No	0.0	0	0.00%	1	1.33%												
503	2 BED	No	Yes	Yes	Yes	Yes	Yes	Yes	2.5	1	1.33%	0	0.00%						
504	2 BED	Yes	6.0	1	1.33%	0	0.00%												
505	2 BED	Yes	6.0	1	1.33%	0	0.00%												
506	2 BED	Yes	6.0	1	1.33%	0	0.00%												
507	1 BED	Yes	Yes	Yes	Yes	Yes	No	2.0	1	1.33%	0	0.00%							
01	2 BED	Yes	Yes	Yes	Yes	Yes	No	2.0	1	1.33%	0	0.00%							
02	2 BED	No	0.0	0	0.00%	1	1.33%												
03	2 BED	No	Yes	Yes	Yes	Yes	Yes	Yes	2.5	1	1.33%	0	0.00%						
i04	2 BED	Yes	6.0	1	1.33%	0	0.00%												
i05	2 BED	Yes	6.0	1	1.33%	0	0.00%												
606	2 BED	Yes	6.0	1	1.33%	0	0.00%												
107	1 BED	Yes	Yes	Yes	Yes	Yes	No	2.0	1	1.33%	0	0.00%							
01	2 BED	Yes	Yes	Yes	Yes	Yes	No	2.0	1	1.33%	0	0.00%							
02	2 BED	No	0.0	0	0.00%	1	1.33%												
03	2 BED	No	Yes	Yes	Yes	Yes	Yes	Yes	2.5	1	1.33%	0	0.00%						
'04	2 BED	Yes	6.0	1	1.33%	0	0.00%												
'05	2 BED	Yes	6.0	1	1.33%	0	0.00%												
'06	2 BED	Yes	6.0	1	1.33%	0	0.00%												
'07	1 BED	Yes	Yes	Yes	Yes	Yes	No	2.0	1	1.33%	0	0.00%							
101	2 BED	Yes	Yes	Yes	Yes	Yes	No	2.0	1	1.33%	0	0.00%							
102	2 BED	No	0.0	0	0.00%	1	1.33%												
103	2 BED	No	Yes	Yes	Yes	Yes	Yes	Yes	2.5	1	1.33%	0	0.00%						
04	2 BED	Yes	6.0	1	1.33%	0	0.00%												
05	2 BED	Yes	6.0	1	1.33%	0	0.00%												
06	2 BED	Yes	6.0	1	1.33%	0	0.00%												
07	1 BED	Yes	Yes	Yes	Yes	Yes	No	2.0	1	1.33%	0	0.00%							
01	2 BED	Yes	Yes	Yes	Yes	Yes	No	2.0	1	1.33%	0	0.00%							
102	2 BED	No	0.0	0	0.00%	1	1.33%												
103	2 BED	No	Yes	Yes	Yes	Yes	Yes	Yes	2.5	1	1.33%	0	0.00%						
104	2 BED	Yes	6.0	1	1.33%	0	0.00%												
105	2 BED	Yes	6.0	1	1.33%	0	0.00%												
106	2 BED	Yes	6.0	1	1.33%	0	0.00%												
07	1 BED	Yes	Yes	Yes	Yes	Yes	No	2.0	1	1.33%	0	0.00%							
001	2 BED	Yes	Yes	Yes	Yes	Yes	No	2.0	1	1.33%	0	0.00%							
002	2 BED	No	0.0	0	0.00%	1	1.33%												
003	2 BED	No	Yes	Yes	Yes	Yes	Yes	Yes	2.5	1	1.33%	0	0.00%						
004	2 BED	Yes	6.0	1	1.33%	0	0.00%												
005	2 BED	Yes	6.0	1	1.33%	0	0.00%												
006	2 BED	Yes	6.0	1	1.33%	0	0.00%												
007	1 BED	Yes	Yes	Yes	Yes	Yes	No	2.0	1	1.33%	0	0.00%							

UNIT NO.	UNIT TYPE	0900	0930	1000	1030	1100	1130	1200	1230	1300	1330	1400	1430	1500	TOTAL	2HRS	%	NIL HRS	% NIL HRS
1101	2 BED	Yes	Yes	Yes	Yes	Yes	No	2.0	1	1.33%	0	0.00%							
102	2 BED	No	0.0	0	0.00%	1	1.33%												
103	2 BED	No	Yes	Yes	Yes	Yes	Yes	Yes	2.5	1	1.33%	0	0.00%						
1104	2 BED	Yes	6.0	1	1.33%	0	0.00%												
105	2 BED	Yes	6.0	1	1.33%	0	0.00%												
106	2 BED	Yes	6.0	1	1.33%	0	0.00%												
1107	1 BED	Yes	Yes	Yes	Yes	Yes	No	2.0	1	1.33%	0	0.00%							
1201	2 BED	Yes	Yes	Yes	Yes	Yes	No	2.0	1	1.33%	0	0.00%							
1201	2 BED	No	0.0	0	0.00%	1	1.33%												
1203	2 BED	No	Yes	Yes	Yes	Yes	Yes	Yes	2.5	1	1.33%	0	0.00%						
1204	2 BED	Yes	6.0	1	1.33%	0	0.00%												
1205	2 BED	Yes	6.0	1	1.33%	0	0.00%												
1206	2 BED	Yes	6.0	1	1.33%	0	0.00%												
1207	1 BED	Yes	Yes	Yes	Yes	Yes	No	2.0	1	1.33%	0	0.00%							
	-																-		-
1301	2 BED	Yes	Yes	Yes	Yes	Yes	No	2.0	1	1.33%	0	0.00%							
302	2 BED	No	0.0	0	0.00%	1	1.33%												
	2 BED	No	Yes	Yes	Yes	Yes	Yes	Yes	2.5	1	1.33%	0	0.00%						
1304	2 BED	Yes	6.0	1	1.33%	0	0.00%												
1305	2 BED	Yes	6.0	1	1.33%	0	0.00%												
1306	2 BED	Yes	6.0	1	1.33%	0	0.00%												
1307	1 BED	Yes	Yes	Yes	Yes	Yes	No	2.0	1	1.33%	0	0.00%							
1401	2 BED	Yes	Yes	Yes	Yes	Yes	No	2.0	1	1.33%	0	0.00%							
1402	3 BED	No	Yes	Yes	Yes	Yes	1.5	0	0.00%	0	0.00%								
1403	3 BED	No	No	No	No	No	No	Yes	3.0	1	1.33%	0	0.00%						
1404	2 BED	Yes	Yes	Yes	Yes	Yes	No	2.0	1	1.33%	0	0.00%							
1405	1 BED	Yes	Yes	Yes	Yes	Yes	No	2.0	1	1.33%	0	0.00%							
									•										•
1501	2 BED	Yes	Yes	Yes	Yes	Yes	No	2.0	1	1.33%	0	0.00%							
1502	3 BED	No	Yes	Yes	Yes	Yes	1.5	0	0.00%	0	0.00%								
1503	3 BED	Yes	6.0	1	1.33%	0	0.00%												
1504	2 BED	Yes	No	5.5	1	1.33%	0	0.00%											
1505	1 BED	Yes	Yes	Yes	Yes	Yes	No	2.0	1	1.33%	0	0.00%							
1601	4 BED	Yes	6.0	1	1.33%	0	0.00%												
1602	4 BED	Yes	6.0	1	1.33%	0	0.00%												
OTAL: 75	1.500	100	100	100	160	100	160	100	100	100	100	100	100	100	0.0	64	85.33%	9	12.00%

AMENDMENT
CONSULTANT REVIEW
CLIENT REVIEW
ADDITIONAL INFORMATION
PRELIMINARY ADD INFO 23.06.2022 24.06.2022 04.07.2022 13.07.2022



Wollongong 81a Princes Highway, Fairy Meadow NSW 2519 Tel: (02) 4227 1661 Email: info@designworkshop.com.au

Sydney Level 10, 6 Mount Olympus Boulevard, Wolli Creek NSW 2205 Nominated Architect:
Robert Gizzi (Reg. 8286)

DRAWING NAME: ADJACENT DEVELOPMENT ANALYSIS (SOLAR)

CLIENT: ADDRESS:

ANYA SOLUTION Pty Ltd MIXED USE DEVELOPMENT 24-30 KENNY STREET, WOLLONGONG, NSW

ADDITIONAL INFORMATION ISSUE DATE: 28.11.2022 PROJECT No. 2289 DRAWN: NT DWG No. Rev. SCALE:

А3

ВВ

089

QA: RG

					SOLA	R COMF	PLIANCE (HOURL	Y)				
UNIT NO.	UNIT TYPE	0900	1000	1100	1200	1300	1400	1500	TOTAL	2HRS	%	NIL HRS	% NIL HRS
LEVEL 5													
501	2 BED	Yes	Yes	Yes	No	No	No	No	2	1	1.33%	0	0.00%
502	2 BED	No	No	No	No	No	No	No	0	0	0.00%	1	1.33%
503	2 BED	No	No	No	No	Yes	Yes	Yes	2	1	1.33%	0	0.00%
504	2 BED	Yes	Yes	Yes	Yes	Yes	Yes	Yes	6	1	1.33%	0	0.00%
505	2 BED	Yes	Yes	Yes	Yes	Yes	Yes	Yes	6	1	1.33%	0	0.00%
506	2 BED	Yes	Yes	Yes	Yes	Yes	Yes	Yes	6	1	1.33%	0	0.00%
507	1 BED	Yes	Yes	Yes	No	No	No	No	2	1	1.33%	0	0.00%
LEVEL 6												•	
601	2 BED	Yes	Yes	Yes	No	No	No	No	2	1	1.33%	0	0.00%
602	2 BED	No	No	No	No	No	No	No	0	0	0.00%	1	1.33%
603	2 BED	No	No	No	No	Yes	Yes	Yes	2	1	1.33%	0	0.00%
604	2 BED	Yes	Yes	Yes	Yes	Yes	Yes	Yes	6	1	1.33%	0	0.00%
605	2 BED	Yes	Yes	Yes	Yes	Yes	Yes	Yes	6	1	1.33%	0	0.00%
606	2 BED	Yes	Yes	Yes	Yes	Yes	Yes	Yes	6	1	1.33%	0	0.00%
607	1 BED	Yes	Yes	Yes	No	No	No	No	2	1	1.33%	0	0.00%
LEVEL 7													
701	2 BED	Yes	Yes	Yes	No	No	No	No	2	1	1.33%	0	0.00%
702	2 BED	No	No	No	No	No	No	No	0	0	0.00%	1	1.33%
703	2 BED	No	No	No	No	Yes	Yes	Yes	2	1	1.33%	0	0.00%
704	2 BED	Yes	Yes	Yes	Yes	Yes	Yes	Yes	6	1	1.33%	0	0.00%
705	2 BED	Yes	Yes	Yes	Yes	Yes	Yes	Yes	6	1	1.33%	0	0.00%
706	2 BED	Yes	Yes	Yes	Yes	Yes	Yes	Yes	6	1	1.33%	0	0.00%
707	1 BED	Yes	Yes	Yes	No	No	No	No	2	1	1.33%	0	0.00%
LEVEL 8							-						
801	2 BED	Yes	Yes	Yes	No	No	No	No	2	1	1.33%	0	0.00%
802	2 BED	No	No	No	No	No	No	No	0	0	0.00%	1	1.33%
803	2 BED	No	No	No	No	Yes	Yes	Yes	2	1	1.33%	0	0.00%
804	2 BED	Yes	Yes	Yes	Yes	Yes	Yes	Yes	6	1	1.33%	0	0.00%
805	2 BED	Yes	Yes	Yes	Yes	Yes	Yes	Yes	6	1	1.33%	0	0.00%
806	2 BED	Yes	Yes	Yes	Yes	Yes	Yes	Yes	6	1	1.33%	0	0.00%
807	1 BED	Yes	Yes	Yes	No	No	No	No	2	1	1.33%	0	0.00%
LEVEL 9					•								·
901	2 BED	Yes	Yes	Yes	No	No	No	No	2	1	1.33%	0	0.00%
902	2 BED	No	No	No	No	No	No	No	0	0	0.00%	1	1.33%
903	2 BED	No	No	No	No	Yes	Yes	Yes	2	1	1.33%	0	0.00%
904	2 BED	Yes	Yes	Yes	Yes	Yes	Yes	Yes	6	1	1.33%	0	0.00%
905	2 BED	Yes	Yes	Yes	Yes	Yes	Yes	Yes	6	1	1.33%	0	0.00%
906	2 BED	Yes	Yes	Yes	Yes	Yes	Yes	Yes	6	1	1.33%	0	0.00%
907	1 BED	Yes	Yes	Yes	No	No	No	No	2	1	1.33%	0	0.00%
LEVEL 10			•				•					•	•
1001	2 BED	Yes	Yes	Yes	No	No	No	No	2	1	1.33%	0	0.00%
1002	2 BED	No	No	No	No	No	No	No	0	0	0.00%	1	1.33%
1003	2 BED	No	No	No	No	Yes	Yes	Yes	2	1	1.33%	0	0.00%
1004	2 BED	Yes	Yes	Yes	Yes	Yes	Yes	Yes	6	1	1.33%	0	0.00%
1005	2 BED	Yes	Yes	Yes	Yes	Yes	Yes	Yes	6	1	1.33%	0	0.00%
1006	2 BED	Yes	Yes	Yes	Yes	Yes	Yes	Yes	6	1	1.33%	0	0.00%
1007	1 BED	Yes	Yes	Yes	No	No	No	No	2	1	1.33%	0	0.00%
	_												

EVEL 11 101 102 103 104 105	UNIT TYPE	0900	1000	1400									
101 102 103 104 105	2 BED			1100	1200	1300	1400	1500	TOTAL	2HRS	%	NIL HRS	% NIL HR
101 102 103 104 105	2 BED												
103 104 105		Yes	Yes	Yes	No	No	No	No	2	1	1.33%	0	0.00%
104		No	0	0	0.00%	1	1.33%						
105	2 BED	No	No	No	No	Yes	Yes	Yes	2	1	1.33%	0	0.00%
	2 BED	Yes	6	1	1.33%	0	0.00%						
106	2 BED	Yes	6	1	1.33%	0	0.00%						
	2 BED	Yes	6	1	1.33%	0	0.00%						
	1 BED	Yes	Yes	Yes	No	No	No	No	2	1	1.33%	0	0.00%
EVEL 12													
	2 BED	Yes	Yes	Yes	No	No	No	No	2	1	1.33%	0	0.00%
202	2 BED	No	0	0	0.00%	1	1.33%						
203	2 BED	No	No	No	No	Yes	Yes	Yes	2	1	1.33%	0	0.00%
204	2 BED	Yes	6	1	1.33%	0	0.00%						
205	2 BED	Yes	6	1	1.33%	0	0.00%						
	2 BED	Yes	6	1	1.33%	0	0.00%						
207	1 BED	Yes	Yes	Yes	No	No	No	No	2	1	1.33%	0	0.00%
EVEL 13													
301	2 BED	Yes	Yes	Yes	No	No	No	No	2	1	1.33%	0	0.00%
302	2 BED	No	0	0	0.00%	1	1.33%						
303	2 BED	No	No	No	No	Yes	Yes	Yes	2	1	1.33%	0	0.00%
304	2 BED	Yes	6	1	1.33%	0	0.00%						
305	2 BED	Yes	6	1	1.33%	0	0.00%						
306	2 BED	Yes	6	1	1.33%	0	0.00%						
307	1 BED	Yes	Yes	Yes	No	No	No	No	2	1	1.33%	0	0.00%
EVEL 14													
401	2 BED	Yes	Yes	Yes	No	No	No	No	2	1	1.33%	0	0.00%
402	3 BED	No	No	No	No	Yes	Yes	Yes	2	1	1.33%	0	0.00%
403	3 BED	Yes	6	1	1.33%	0	0.00%						
	2 BED	Yes	6	1	1.33%	0	0.00%						
405	1 BED	Yes	Yes	Yes	No	No	No	No	2	1	1.33%	0	0.00%
EVEL 15					1		1	•	•				
501	2 BED	Yes	Yes	Yes	No	No	No	No	2	1	1.33%	0	0.00%
502	3 BED	No	No	No	No	No	Yes	Yes	1	0	0.00%	0	0.00%
503	3 BED	Yes	6	1	1.33%	0	0.00%						
504	2 BED	Yes	6	1	1.33%	0	0.00%						
505	1 BED	Yes	Yes	Yes	No	No	No	No	2	1	1.33%	0	0.00%
EVEL 16													
	4 BED	Yes	6	1	1.33%	0	0.00%						
	4 BED	Yes	6	1	1.33%	0	0.00%						

AMENDMENT
CONSULTANT ISSUE
DA SUBMISSION
CLIENT REVIEW DATE 04.11.2021 02.12.2021 24.06.2022 04.07.2022 ADDITIONAL INFORMATION

W 19.07.2022 ADDITIONAL INFORMATION

DISCLAIMER
All dimensions are in millimeters. Verify all dimensions on site prior to commencement of any work.

DESIGN WORKSHOP AUSTRALIA

Wollongong 81a Princes Highway, Fairy Meadow NSW 2519 Tel: (02) 4227 1661 Email: info@designworkshop.com.au

Web: www.designworkshop.com.au


Sydney Level 10, 6 Mount Olympus Boulevard, Wolli Creek NSW 2205 Nominated Architect: Robert Gizzi (Reg. 8286) DRAWING NAME: SOLAR CALCULATIONS

CLIENT: 24-30 KENNY STREET, WOLLONGONG, NSW ADDRESS:


ANYA SOLUTION Pty Ltd MIXED USE DEVELOPMENT

ADDITIONAL INFORMATION


ISSUE DATE: PROJECT No. 28.11.2022 2289 DRAWN: ML DWG No. Rev. SCALE: 094 ВВ QA: RG

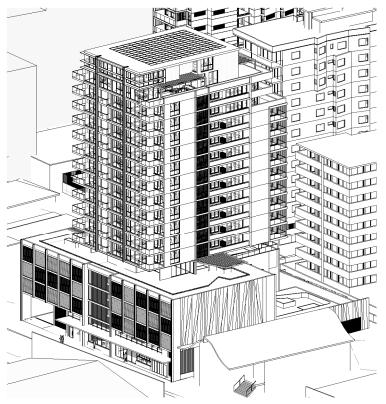


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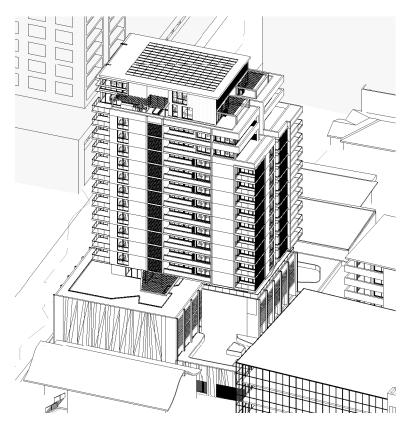
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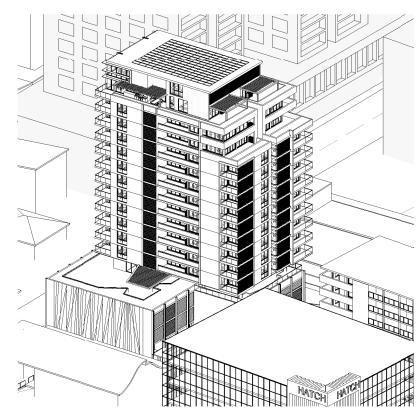
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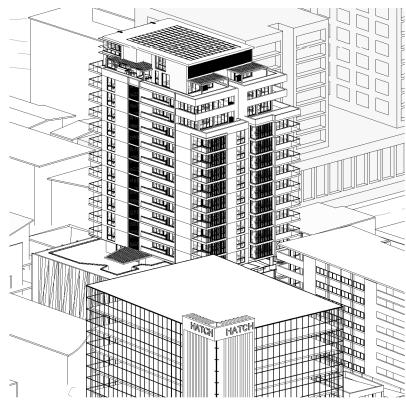
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SOLAR ACCESS - 20/06/2020-13.00

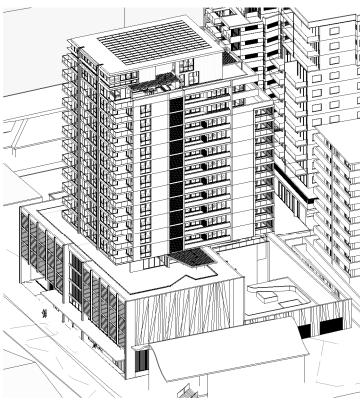

SOLAR ACCESS - 20/06/2020-14.00

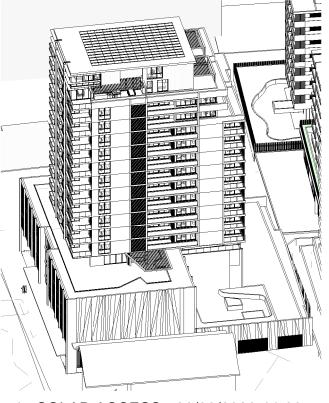

SOLAR ACCESS - 20/06/2020-15.00

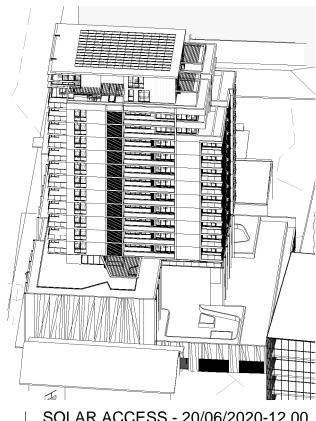AMENDMENT CONSULTANT ISSUE 04.11.2021 02.12.2021 24.06.2022 DA SUBMISSION CLIENT REVIEW ADDITIONAL INFORMATION 04.07.2022

Wollongong 81a Princes Highway, Fairy Meadow NSW 2519 Tel: (02) 4227 1661 Email: info@designworkshop.com.au

Web: www.designworkshop.com.au

Sydney Level 10, 6 Mount Olympus Boulevard, Wolli Creek NSW 2205 Nominated Architect: Robert Gizzi (Reg. 8286)

CLIENT: ADDRESS:


ANYA SOLUTION Pty Ltd MIXED USE DEVELOPMENT

DRAWING NAME: SOLAR ACCESS VIEWS

24-30 KENNY STREET, WOLLONGONG, NSW

ADDITIONAL INFORMATION

PROJECT No. ISSUE DATE: 28.11.2022 2289 DRAWN: NT/SL DWG No. Rev. SCALE: BB 093

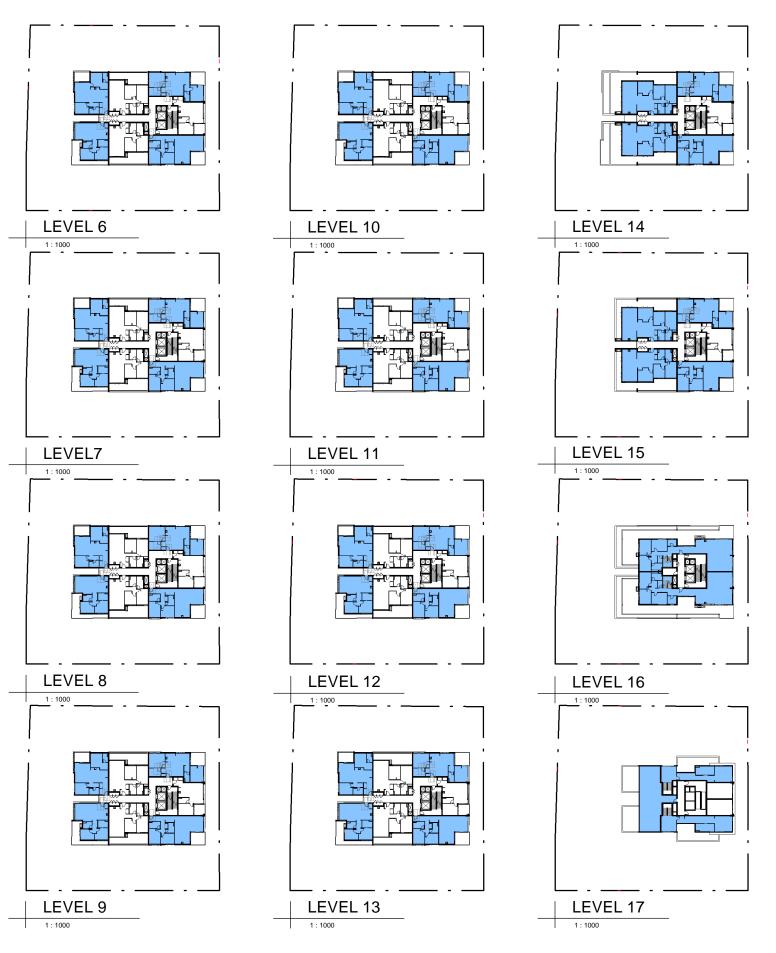

LINIT NO.	LINIT TYPE	CROSS VENT (YES/NO)	ОТУ	0/
UNIT NO:	UNIT TYPE	(TES/NO)	QTY	%
LEVEL 5				
501	2 BED	Yes	1	1.33%
502	2 BED	No	0	0.009
503	2 BED	Yes	1	1.339
504	2 BED	Yes	1	1.339
505	2 BED	No	0	0.009
506	2 BED	Yes	1	1.339
507	1 BED	No	0	0.009
LEVEL 6				
601	2 BED	Yes	1	1.339
602	2 BED	No	0	0.009
603	2 BED	Yes	1	1.339
604	2 BED	Yes	1	1.339
605	2 BED	No	0	0.009
606	2 BED	Yes	1	1.339
607	1 BED	No.	0	0.009
LEVEL 7			-	
701	2 BED	Yes	1	1.339
702	2 BED	No No	0	0.009
703	2 BED	Yes	1	1.339
704	2 BED	Yes	1	1.339
705	2 BED	No	0	0.009
706				
707	2 BED	Yes No	1 0	0.009
LEVEL 8	1 BED	INO	U	0.007
	0.050	V	1	4 220
801	2 BED	Yes	1	1.339
802	2 BED	No	0	0.009
803	2 BED	Yes	1	1.339
804	2 BED	Yes	1	1.339
805	2 BED	No	0	0.009
806	2 BED	Yes	1	1.339
807	1 BED	No	0	0.009
LEVEL 9				
901	2 BED	Yes	1	1.339
902	2 BED	No	0	0.009
903	2 BED	Yes	1	1.339
904	2 BED	Yes	1	1.339
905	2 BED	No	0	0.009
906	2 BED	Yes	1	1.339
907	1 BED	No	0	0.009
LEVEL 10				
1001	2 BED	Yes	1	1.339
1002	2 BED	No	0	0.009
1003	2 BED	Yes	1	1.339
1004	2 BED	Yes	1	1.339
1004	2 BED	No	0	0.009
1005	2 BED	Yes	1	1.339
1007	1 BED	No	0	0.009
LEVEL 11				

	CINOSS V	ENTILATION		
UNIT NO:	UNIT TYPE	CROSS VENT (YES/NO)	QTY	%
1102	2 BED	No	0	0.00
1103	2 BED	Yes	1	1.33
1104	2 BED	Yes	1	1.33
1104	2 BED	res No	0	0.00
1106	2 BED	Yes	1	1.33
1107	1 BED	res No	0	0.00
LEVEL 12	I BED	INO	J 0	0.00
1201	2 BED	Yes	1	1.339
1202	2 BED	No.	0	0.00
		***	-	
1203 1204	2 BED 2 BED	Yes	1	1.339
1204	2 BED	Yes No	0	0.00
1205			1	
	2 BED	Yes		1.339
1207	1 BED	No	0	0.00
LEVEL 13 1301	2 BED	Yes	1	1.33
1302	2 BED	res No	0	0.00
		11.5	-	
1303	2 BED	Yes	1	1.339
	2 BED 2 BED	Yes	1	1.339
1305		No	0	0.009
1306	2 BED	Yes	1	1.33
1307	1 BED	No	0	0.009
LEVEL 14	0.000	V	- 41	4 220
1401	2 BED	Yes	1	1.339
1402	3 BED	Yes	1	1.339
1403	3 BED	Yes	1	1.339
1404	2 BED	Yes	1	1.339
1405	1 BED	No	0	0.009
LEVEL 15				
1501	2 BED	Yes	1	1.339
1502	3 BED	Yes	1	1.339
1503	3 BED	Yes	1	1.339
1504	2 BED	Yes	1	1.339
1505	1 BED	No	0	0.00
LEVEL 16				
1601	4 BED	Yes	1	1.339
1602	4 BED	Yes	1	1.339

AMENDMENT
CONSULTANT ISSUE
DA SUBMISSION
CLIENT REVIEW DATE 04.11.2021 02.12.2021 24.06.2022 ADDITIONAL INFORMATION 04.07.2022

DESIGN WORKSHOP AUSTRALIA Web: www.designworkshop.com.au

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Sydney Level 10, 6 Mount Olympus Boulevard, Wolli Creek NSW 2205 Nominated Architect: Robert Gizzi (Reg. 8286)

CLIENT: ADDRESS:

ANYA SOLUTION Pty Ltd MIXED USE DEVELOPMENT 24-30 KENNY STREET, WOLLONGONG, NSW


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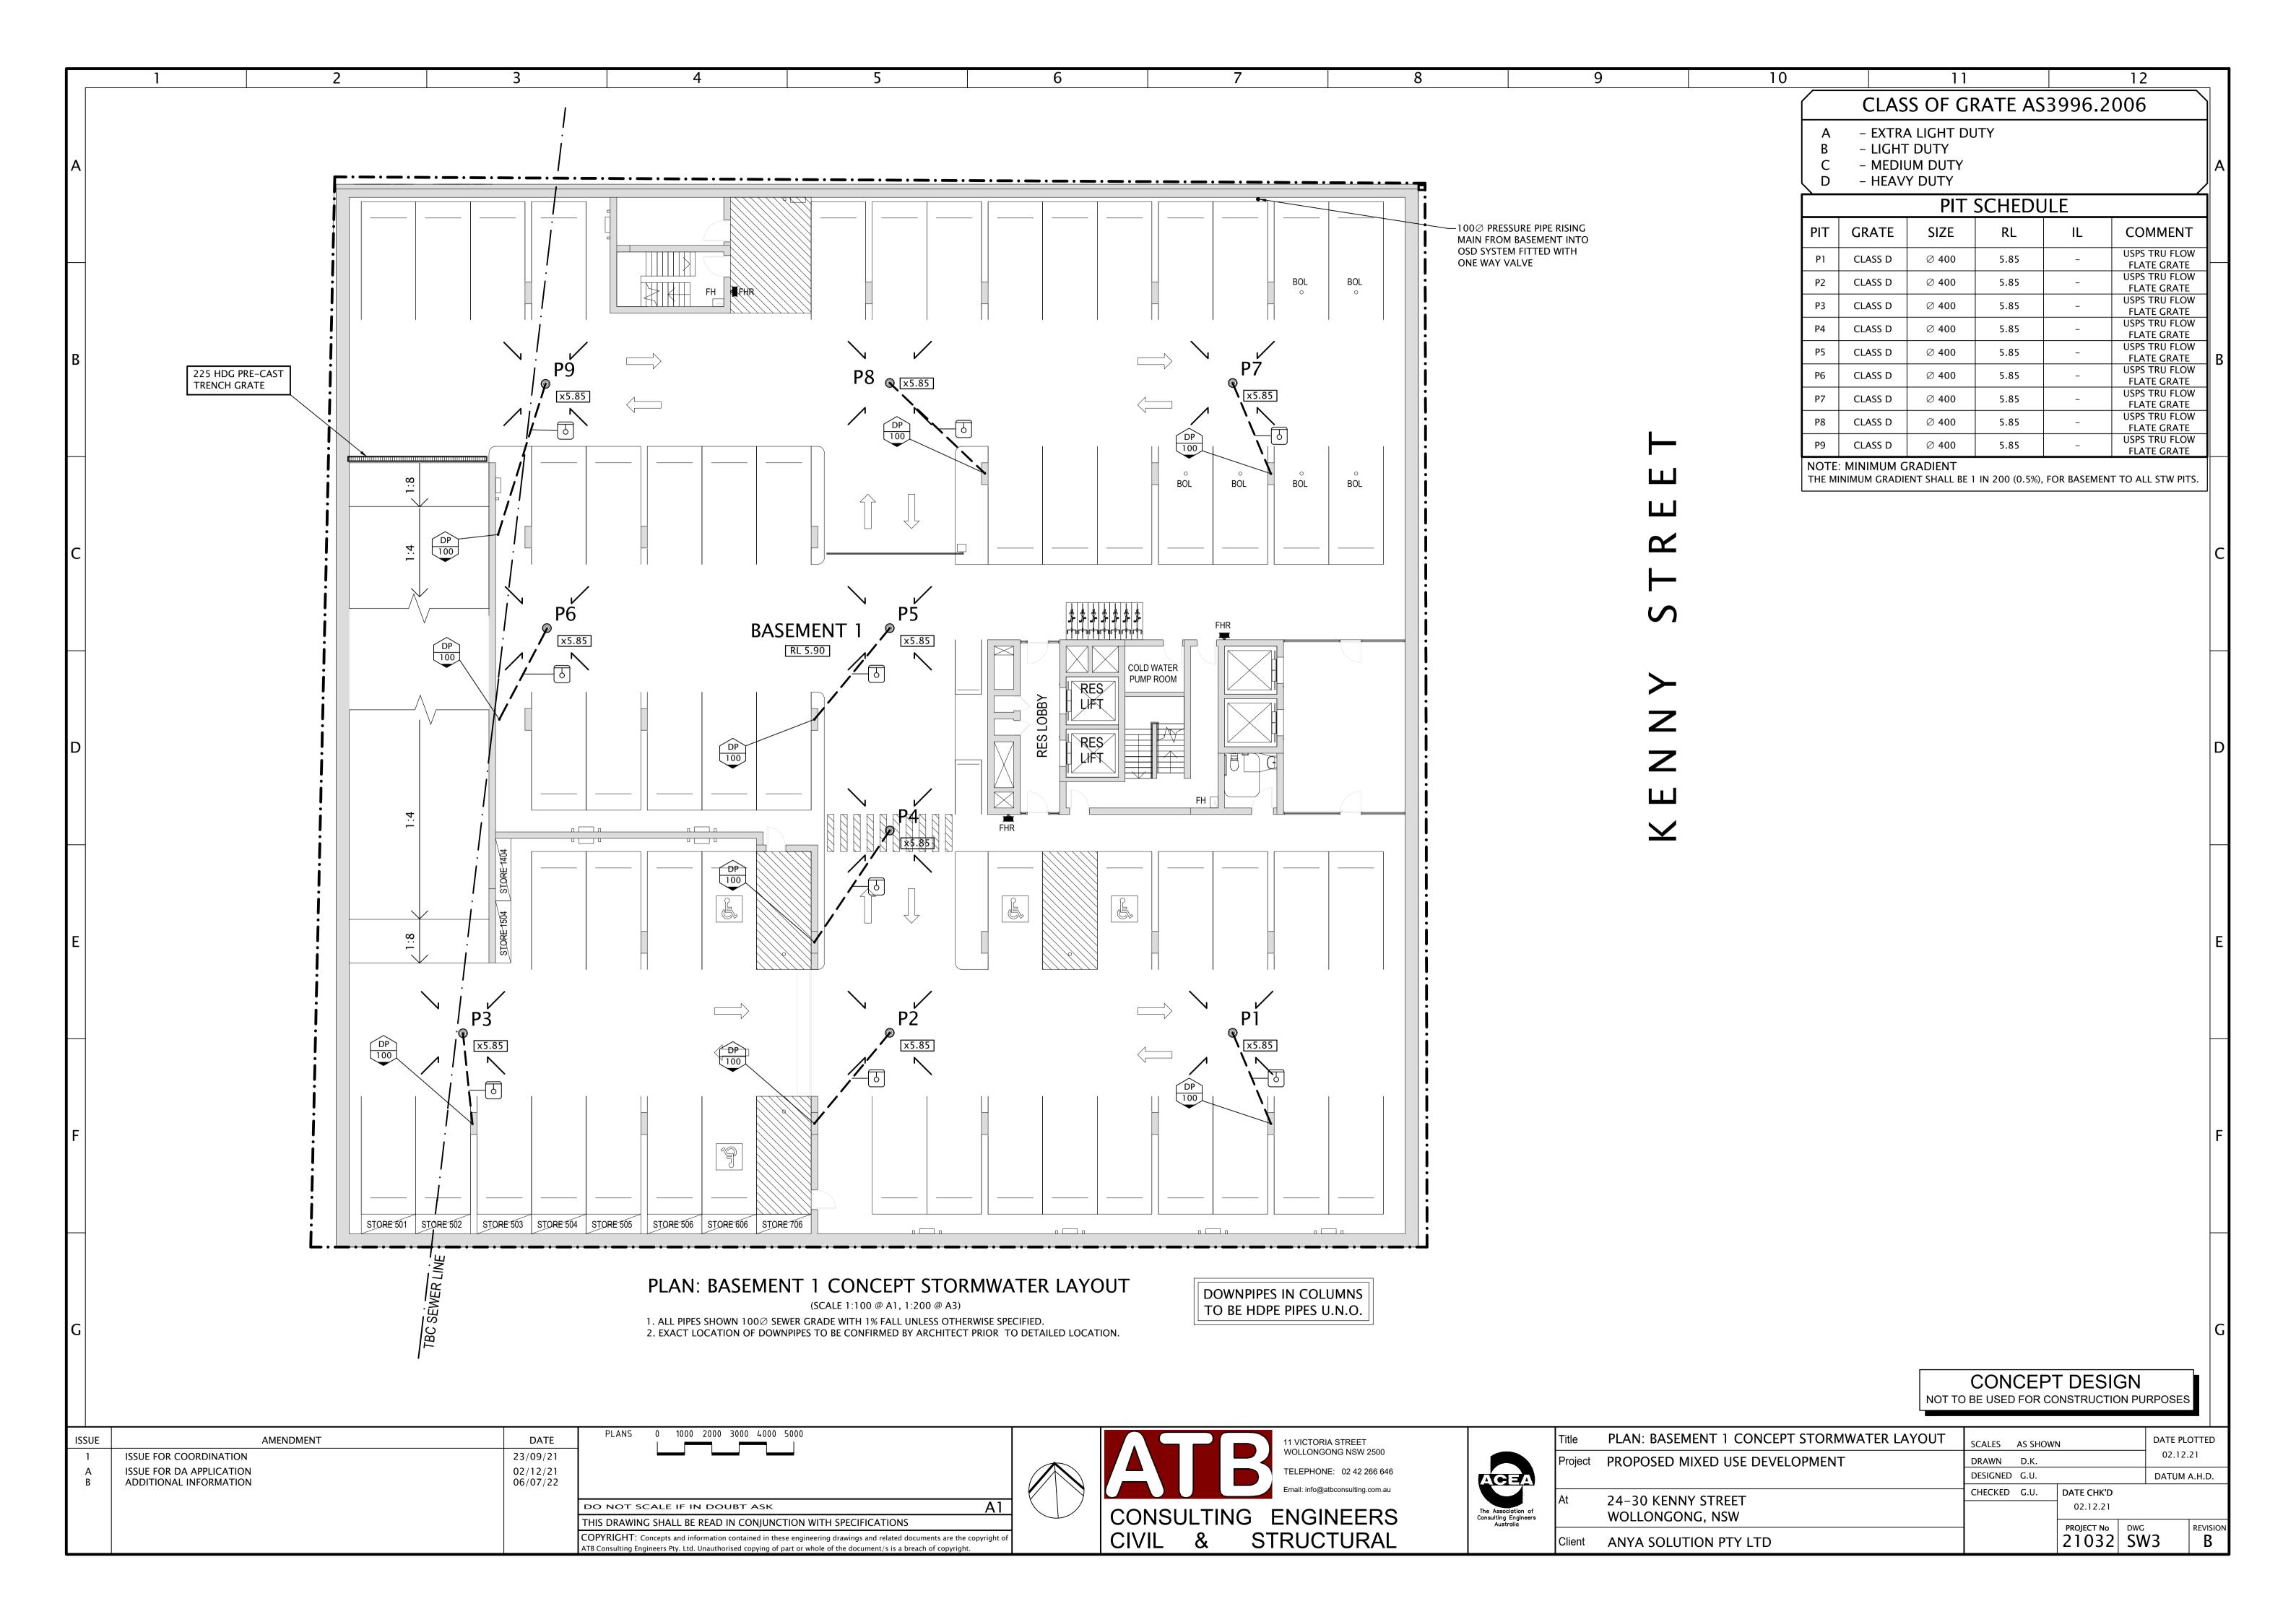
ADDITIONAL INFORMATION





ISSUE DATE: 28.11.2022 SCALE: QA: RG

PROJECT No. 2289 DWG No. Rev. 092 ВВ



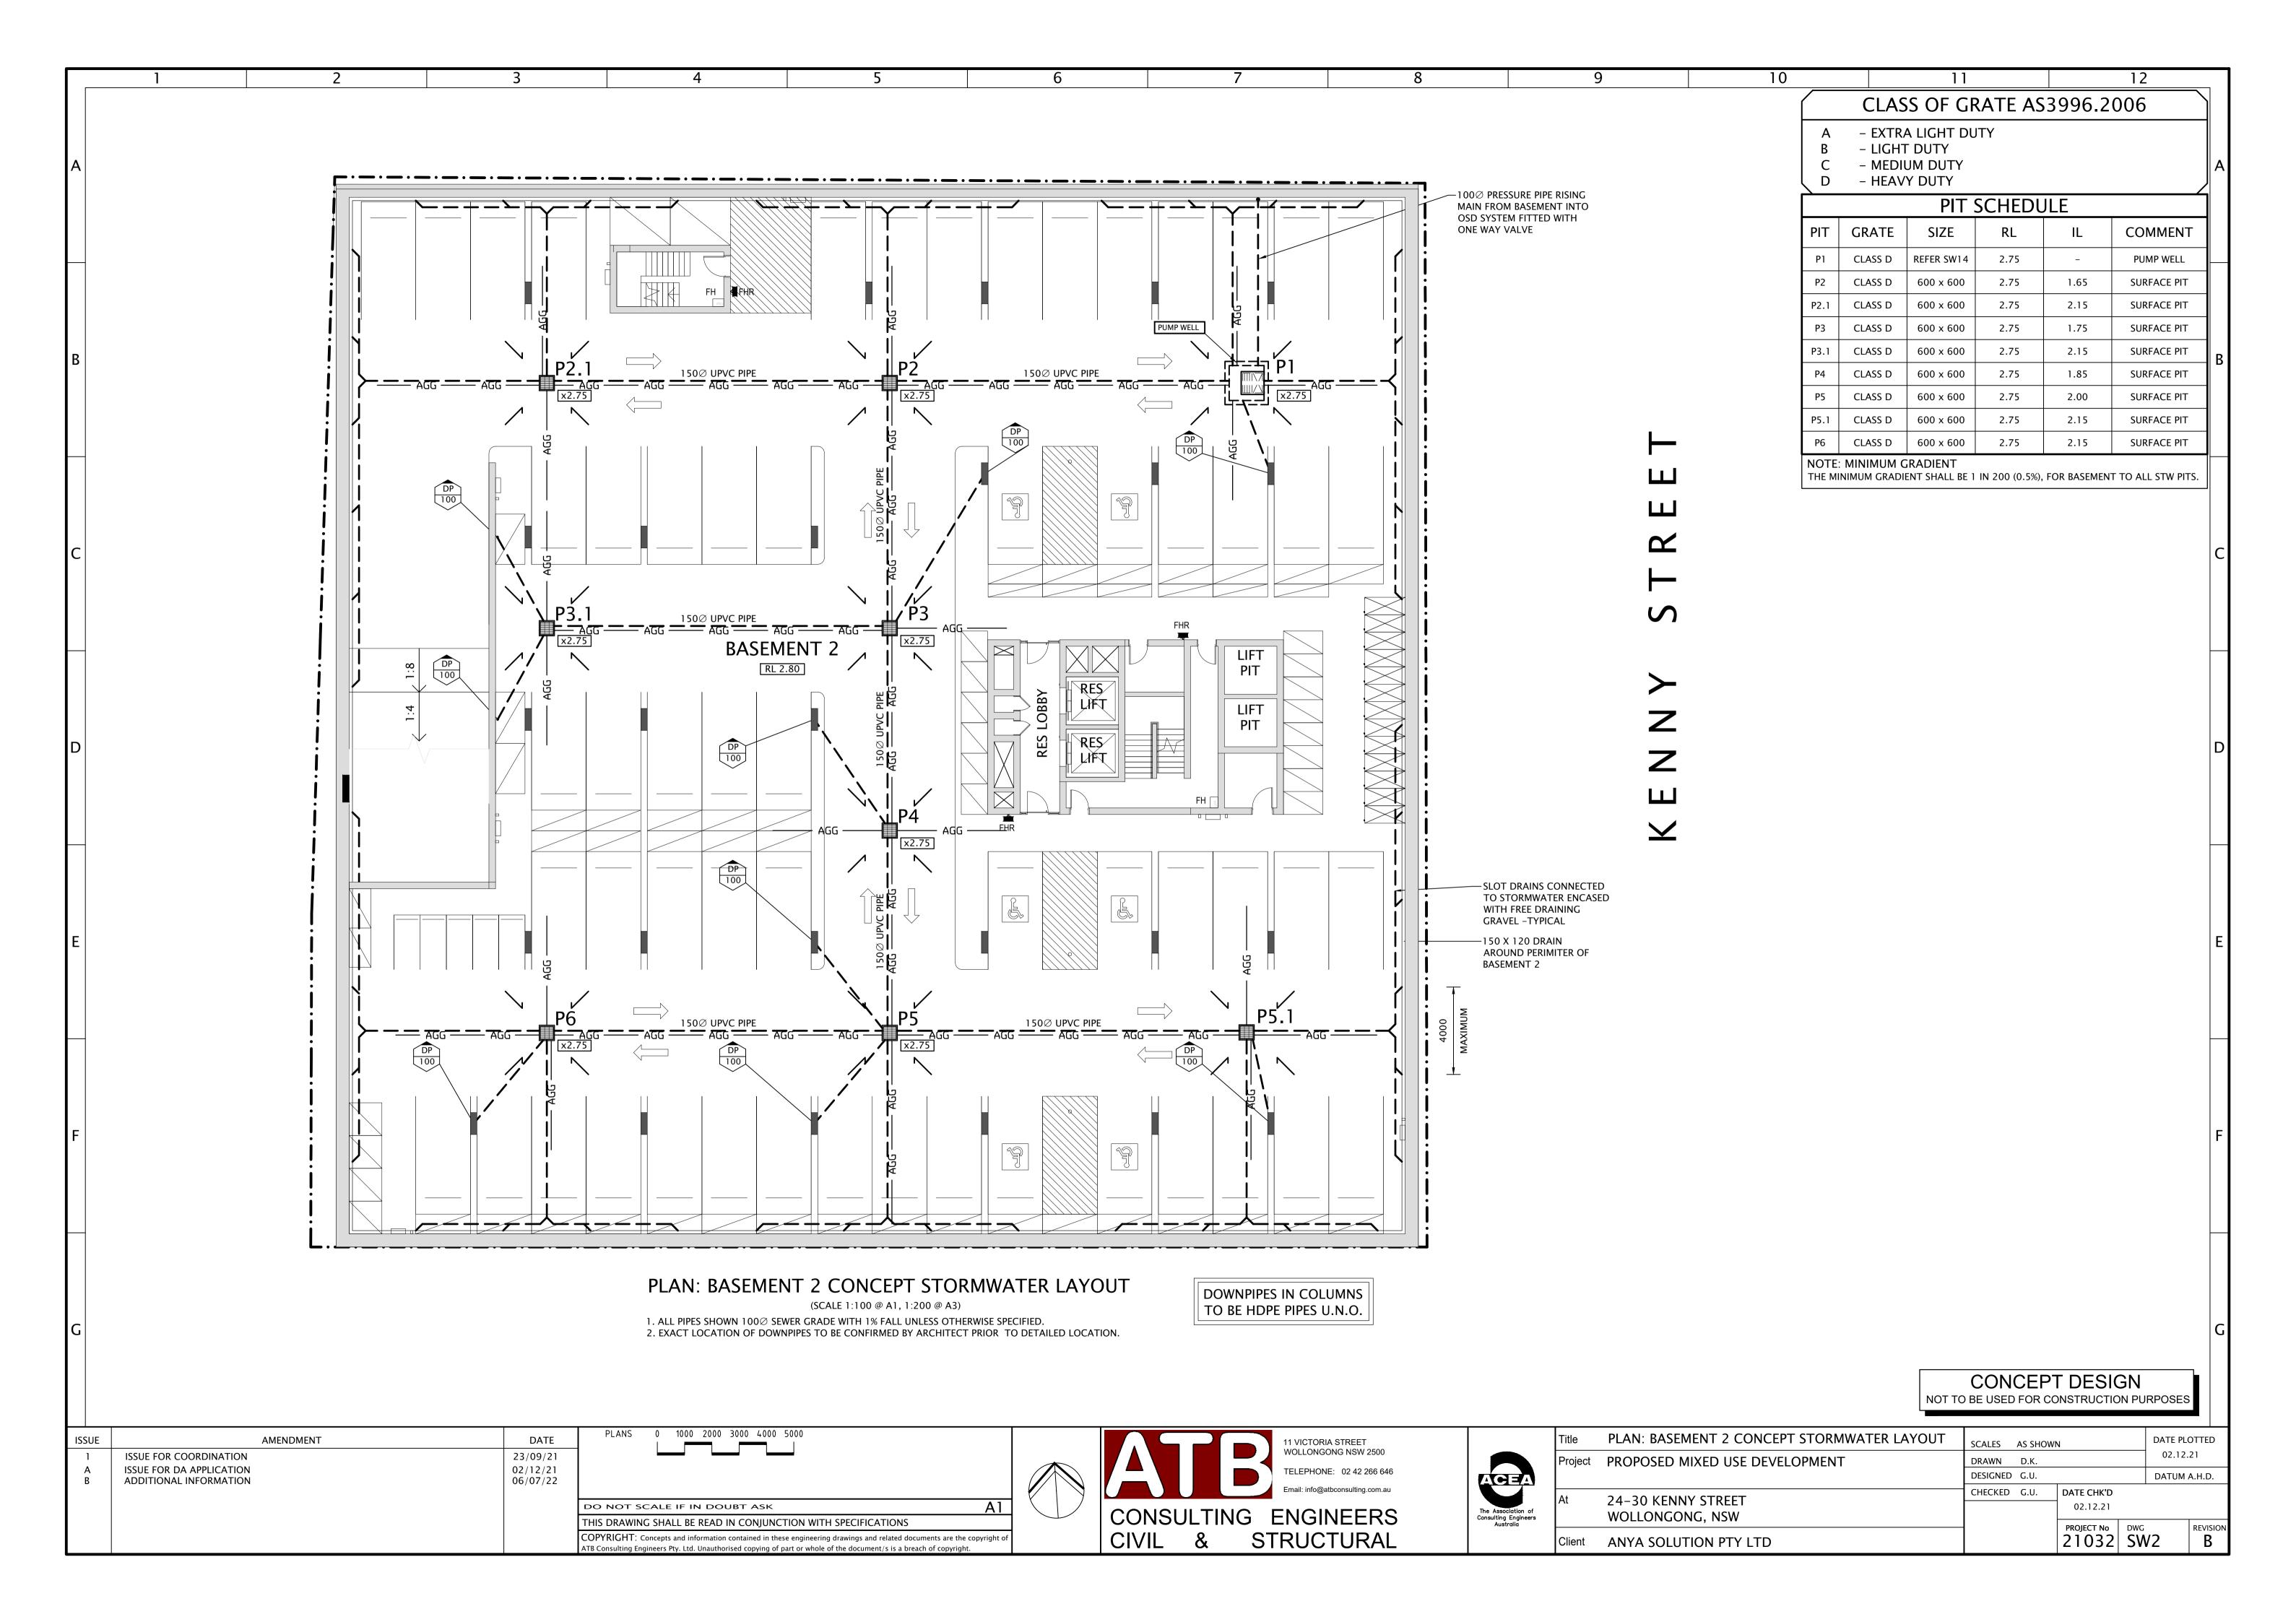

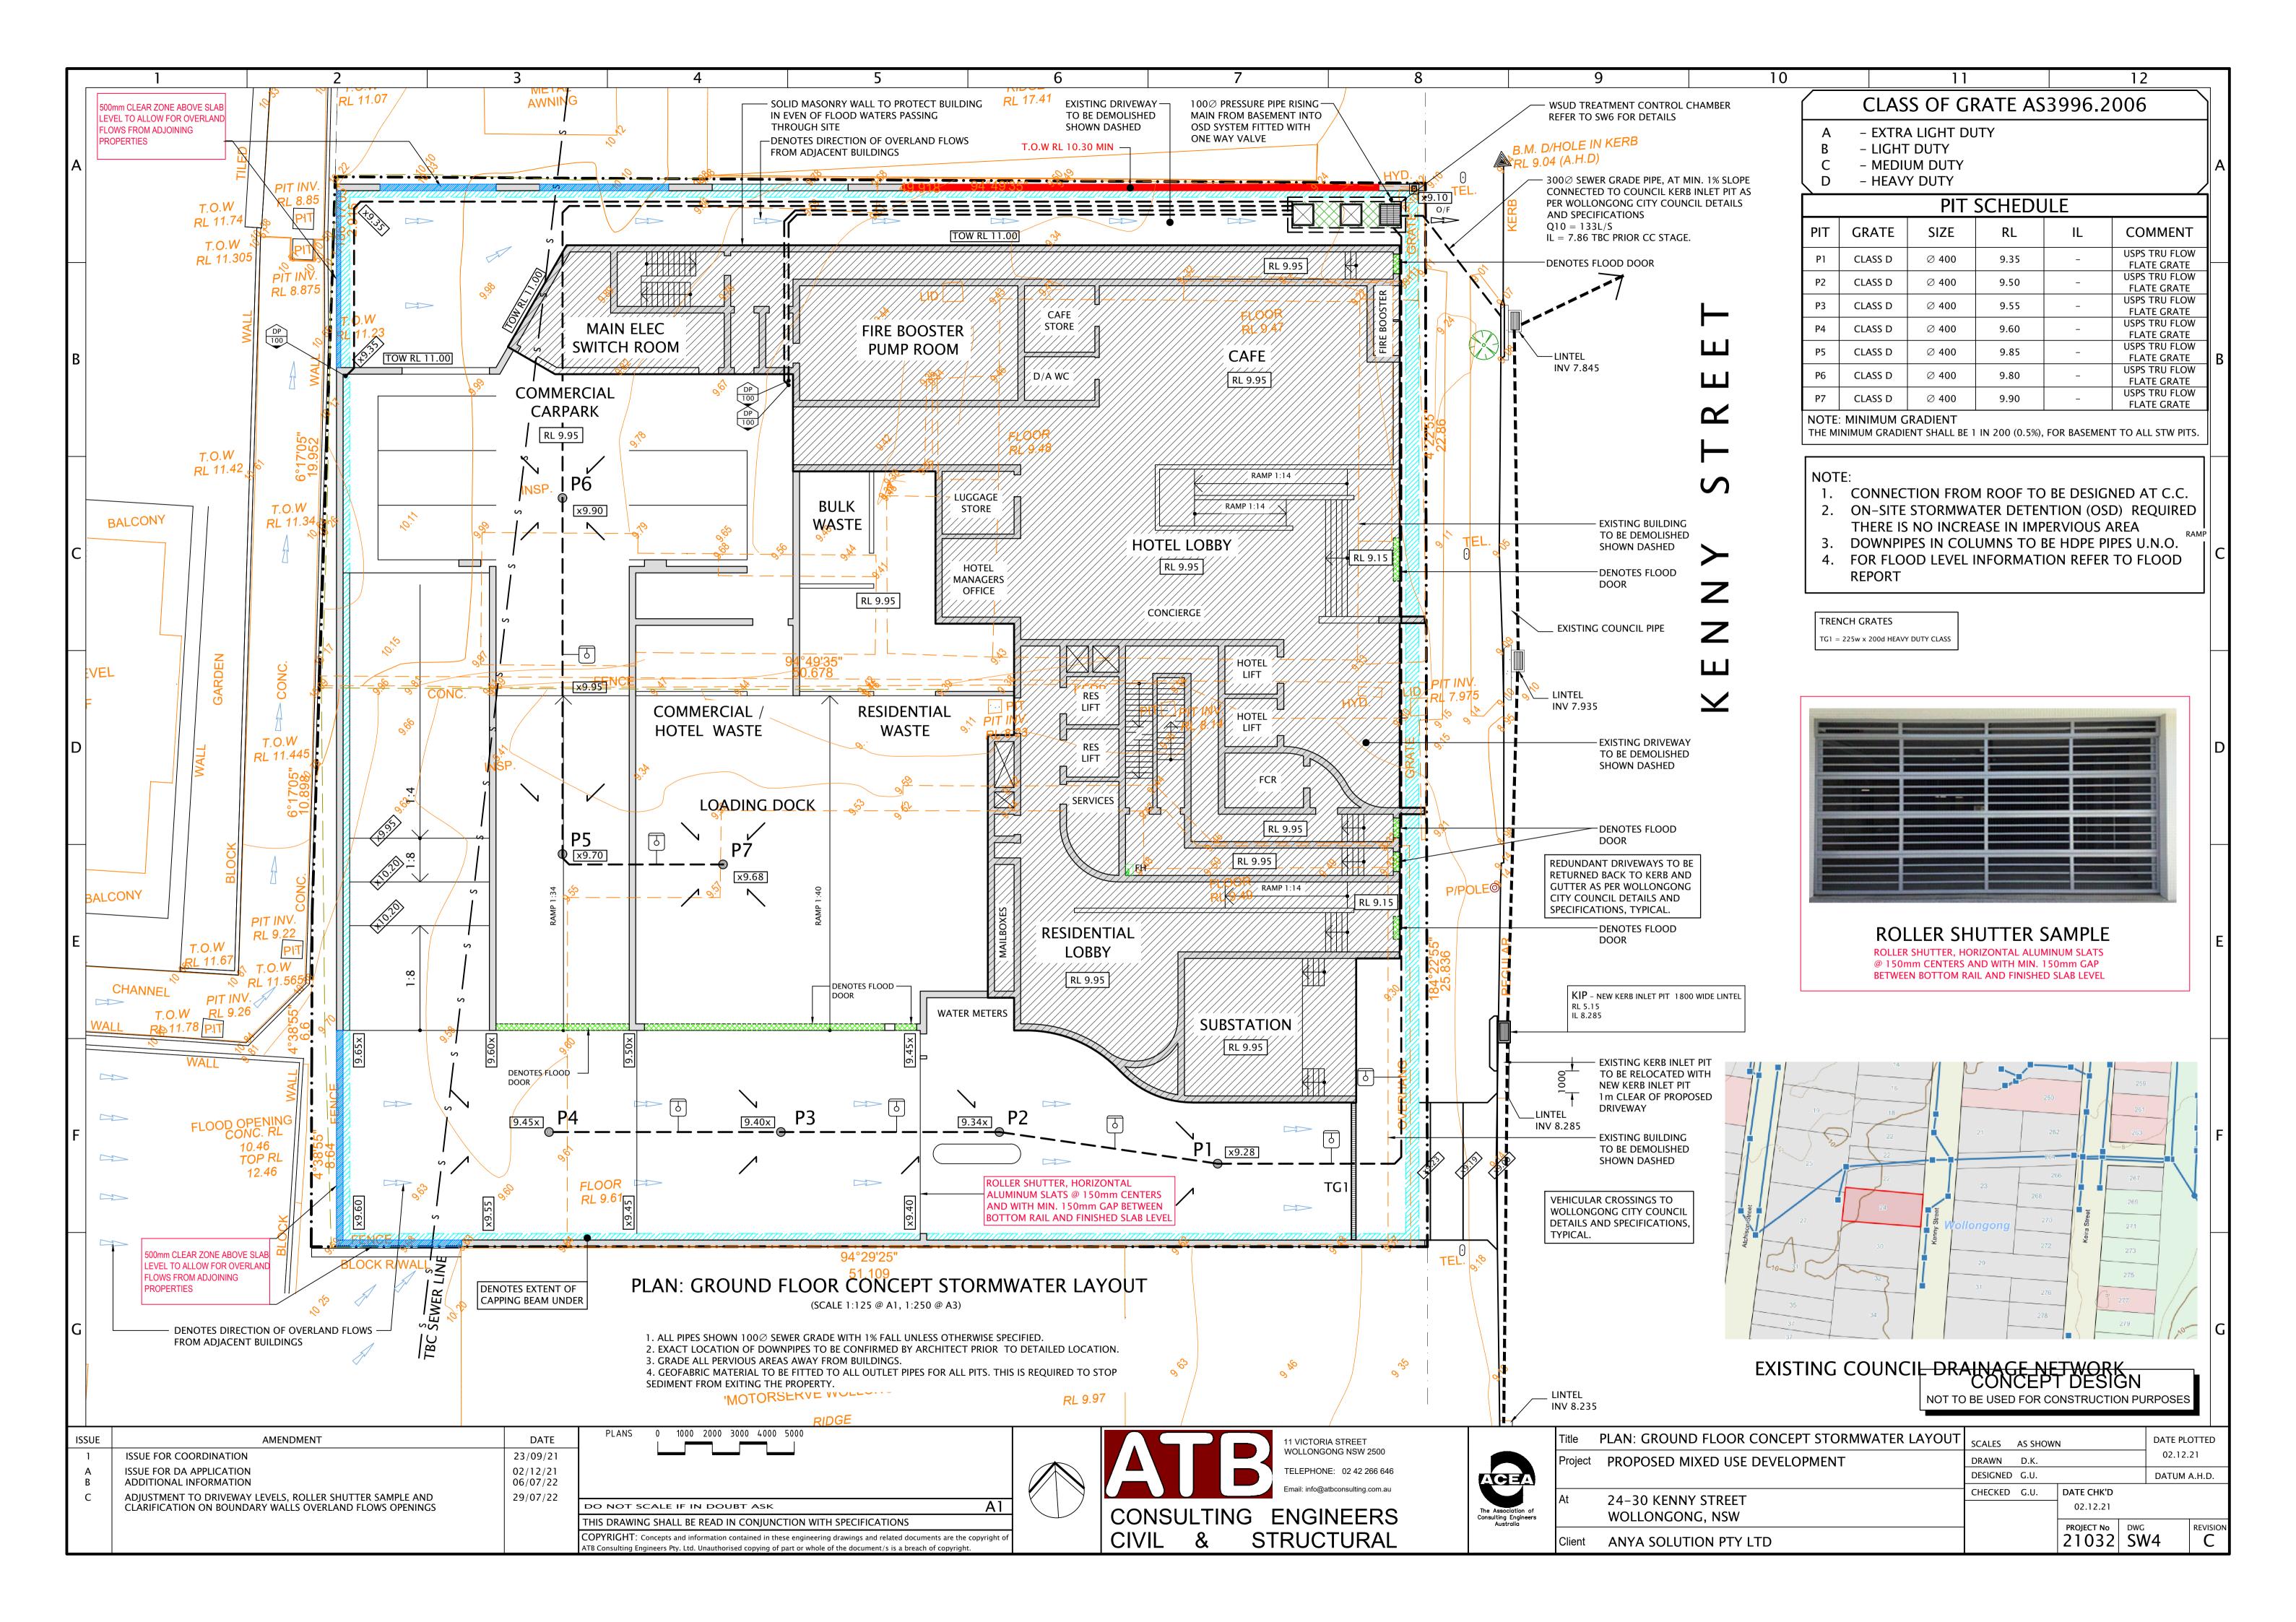

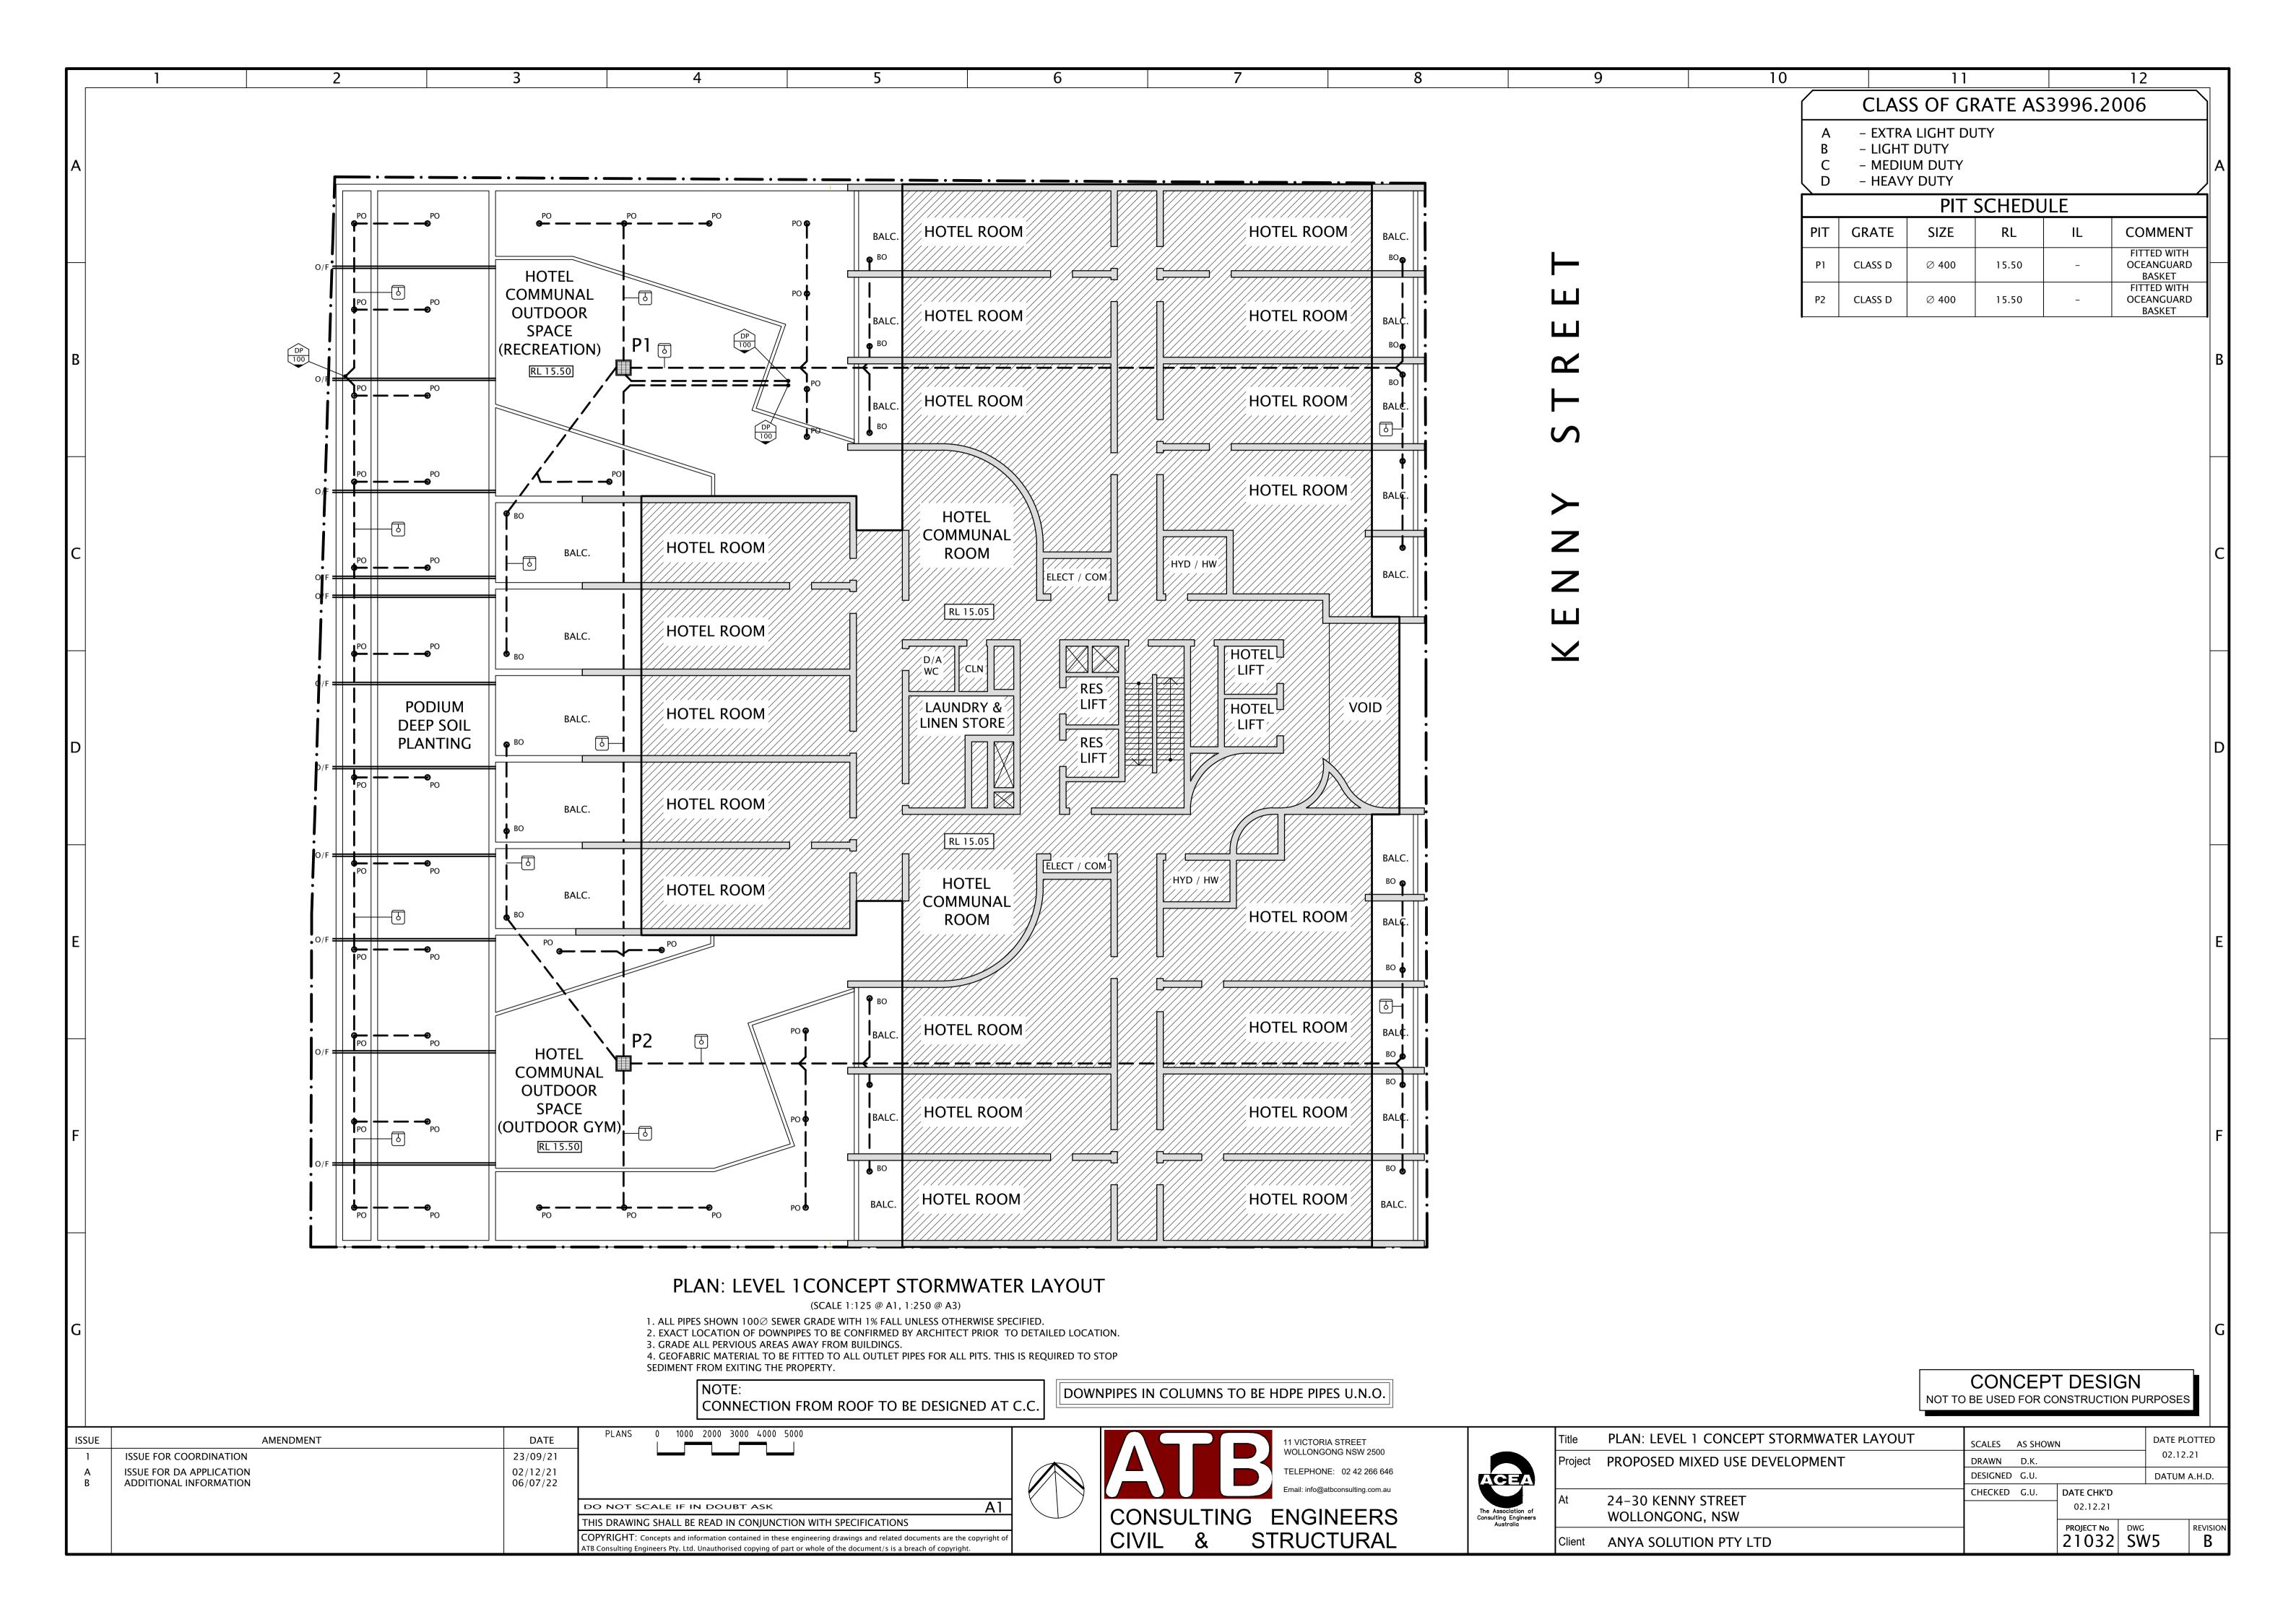

Mixed Use Development

Landscape Development Application 24-30 Kenny Street, Wollongong NSW

Drawing Schedule

Drawing Number	Drawing Title	Scale
000	Landscape Coversheet	N/A
101	Landscape Plan - Ground Floor	1:100
102	Landscape Plan - Level 1	1:100
103	Landscape Plan - Level 2	1:100
104	Landscape Plan - Level 3	1:100
105	Landscape Plan - Level 4	1:100
106	Landscape Plan - Level 14	1:100
107	Landscape Plan - Level 16	1:100
500	Landscape Character	As Shown
501	Landscape Details	As Shown
502	Landscape Details	As Shown
601	Landscape Sections	As Shown

			Mature Size (Height x			
	Botanic Name	Common Name	Width)	Pot Size	Density	Qty
	FLOOR					
STREET						
ZGV	Zelkova serrata 'Green Vase'	Japanese 'Green Vase'	14 x 10	200L	As Shown	3
TREES						
Wfl	Waterhousea floribunda	Weeping Lilly Pilly	12 x 7	110L	As Shown	5
MI	Melaleuca linariifolia	Snow-In-Summer	10 x 4	100L	As Shown	7
TI	Tristaniopsis laurina 'Luscious®'	Watergum	8 x 6	200L	As shown	5
Bm	Backhousia myrtifolia	Cinnamon Myrtle	7 × 4	100L	As Shown	9
Bi	Bank sia integrifolia	Coast Banksia	12 x 4	200L	As Shown	5
Can	Cupaniopsis anacardioides	Tuckeroo	10 x 5	75 L	As Shown	2
Li	Lagerstroemia indica	Crepe Myrtle	5 x 4	200L	As Shown	10
SHRUBS	& ACCENTS					
Aa	Agave Attenuata	Foxtail agave	2 x 1.5	300mm	As shown	46
Aau	Asplenium australasicum	Bird's Nest Fern	1.5 x 1.5	300mm	As shown	27
ABW	Agapanthus 'Bingo White'	Agapanthus	0.5 x 0.5	200mm	As shown	51
AiR	Alcantarea imperialis 'Rubra'	Imperial Bromeliad	1 x 1	300mm	As shown	32
Am	Alpinia mutica	False Cardamon	1.5 x 2	300mm	As shown	127
As	Acmena smithii	Lilly Pilly	5 x 4	300mm	As Shown	100
Bn	Blechnum nudum (Labill.) Mett. Ex Luerss.	Fishbone Water Fern	1 x 1	300mm	As shown	38
Са	Correa alba	White Correa	1.5 x 1.5	300mm	As Shown	98
De	Doryanthes excelsa	Gymea lily	4 x 3	300mm	As shown	44
MT	Metrosideros collina 'Tahiti'	New Zealand Christmas bush	1 x 1	300mm	As Shown	136
Gr	Grevillea rosmarinifolia	Rosemary grevillea	1.8 x 1	300mm	As Shown	83
Od	Ozothamnus diosmifolius	Sago Flower	1.5 x 2.0	300mm	As Shown	63
Px	Philodendron xanadu	Xanadu	1.5 x 1	300mm	As Shown	51
Pt	Phormium tenax	New Zealand Flax	1.8 x 1.5	300mm	As Shown	71
SA	Syzygium 'Australe'	Lillypilly	3 x 2	300mm	As shown	127
Vo	Viburnum odoratissimum	Sweet Viburnum	3 x 3	300mm	As Shown	84
Wf	Westringia fruticosa 'Aussie Box"	Coastal Rosemary	1 x 1	300mm	As shown	162
wwg	Westringia fruticosa x eremicola 'Wynyabbie Gem'	-	2 x 2	300mm	As Shown	51
CDASSE	S & GROUND COVERS					
Car	Clematis aristata	Australia Clematis	2 v 1	150mm	5/m2	261
	Carpobrotus glaucescens	Pig Face	2 x 1	150mm	5/m2	231
Cg Gt	Gazania tomentosa	Silver Gazania	0.3 x 2 0.3 x 1.5	150mm	5/m2	215
Lt	Lomandra tanika	Mat Rush	0.6 x 0.65	150mm	5/m2	130
		Myoporum parvifolium	0.3 x 2	150mm	5/m2	280
Mp	Myoporum parvifolium	Blue Chalksticks	0.3 x 0.9	150mm	5/m2	127
Ss	Senecio serpens			150mm		204
Hv	Hardenbergia violaceae	Hardenbergia	1 x 1	150mm	5/m2	
Wfr	Westringia fruiticosa	Costal Rosemary	0.3 x 2		5/m2	211
Cm	Clivia miniata	Kaffir Lily	1 x 0.8	150mm	5/m2	238
Da	Dichondra argentea	Dichondra Silver Falls	0.15 x 1	150mm	5/m2	233
CLIMBER	RS					
Hs	Hibbertia scandens	Guinea Flower	3 x 5	150mm	As shown	60
Tj	Trachelospermum jasminoies	Star jasmine	0.2 x spreading	150mm	As Shown	60
Cs	Clematis spp.	Leather flower		150mm	As Shown	10




SITE AERIAL | NTS

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F	Architectural Coordination	LW	NM	23.11.2022
E	Development Application	LW	NM	04.07.2022
D	Development Application	LW	NM	01.07.2022
С	Development Application	RH	NM	02.12.2021
В	Development Application	LW	NM	10.11.2021
Α	Draft Development Application	RH	NM	05.11.2021

Legend



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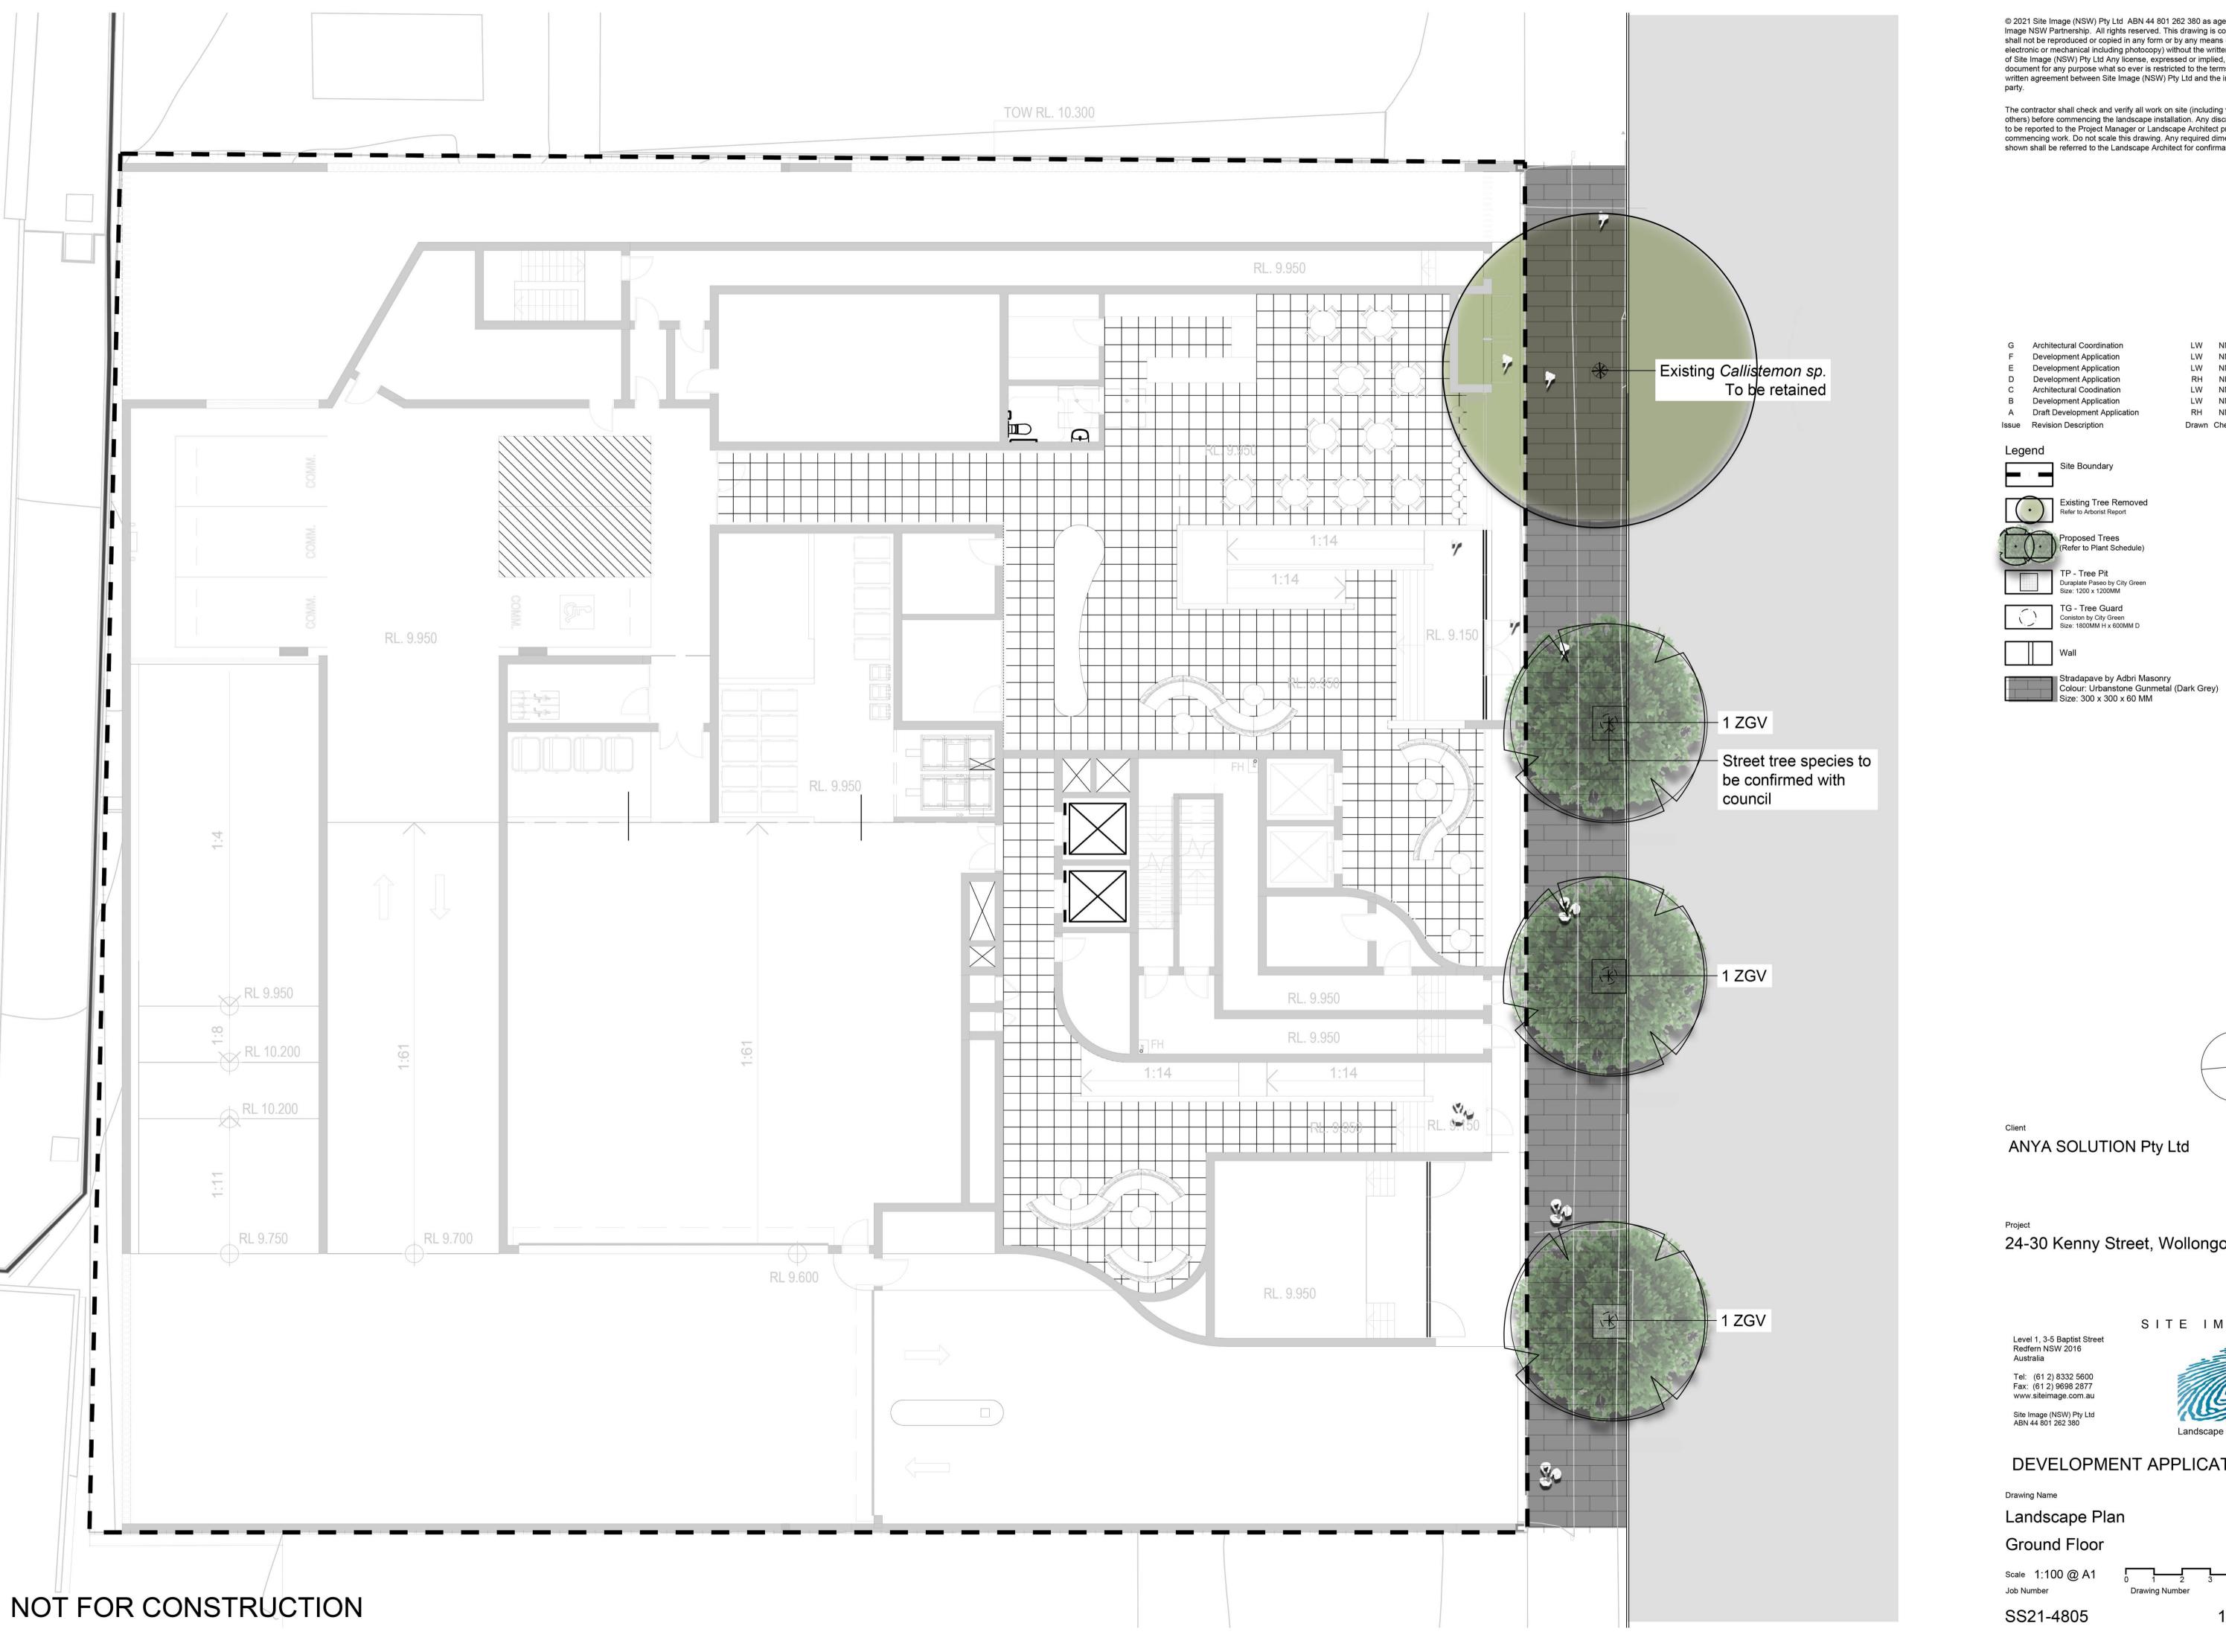
DEVELOPMENT APPLICATION

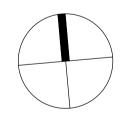Coversheet

SS21-4805


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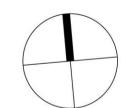
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SITE IMAGE

DEVELOPMENT APPLICATION


Landscape Plan


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Client

ANYA SOLUTION Pty Ltd

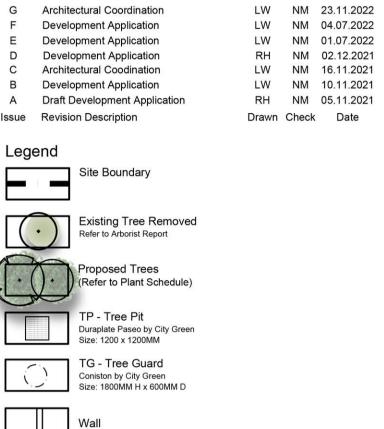Project

24-30 Kenny Street, Wollongong

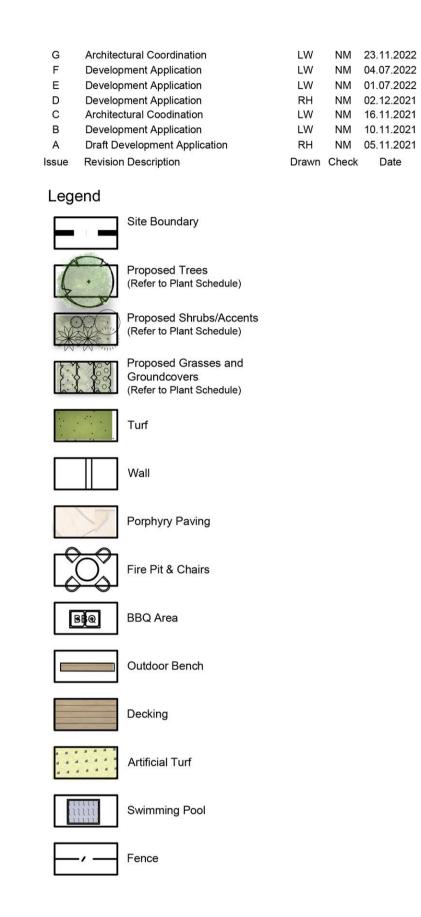

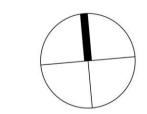DEVELOPMENT APPLICATION

Drawing Name

Landscape Plan


Level 1

Scale 1:100 @ A1 0 1 2 3 4

Job Number Drawing Number

SS21-4805

102 G

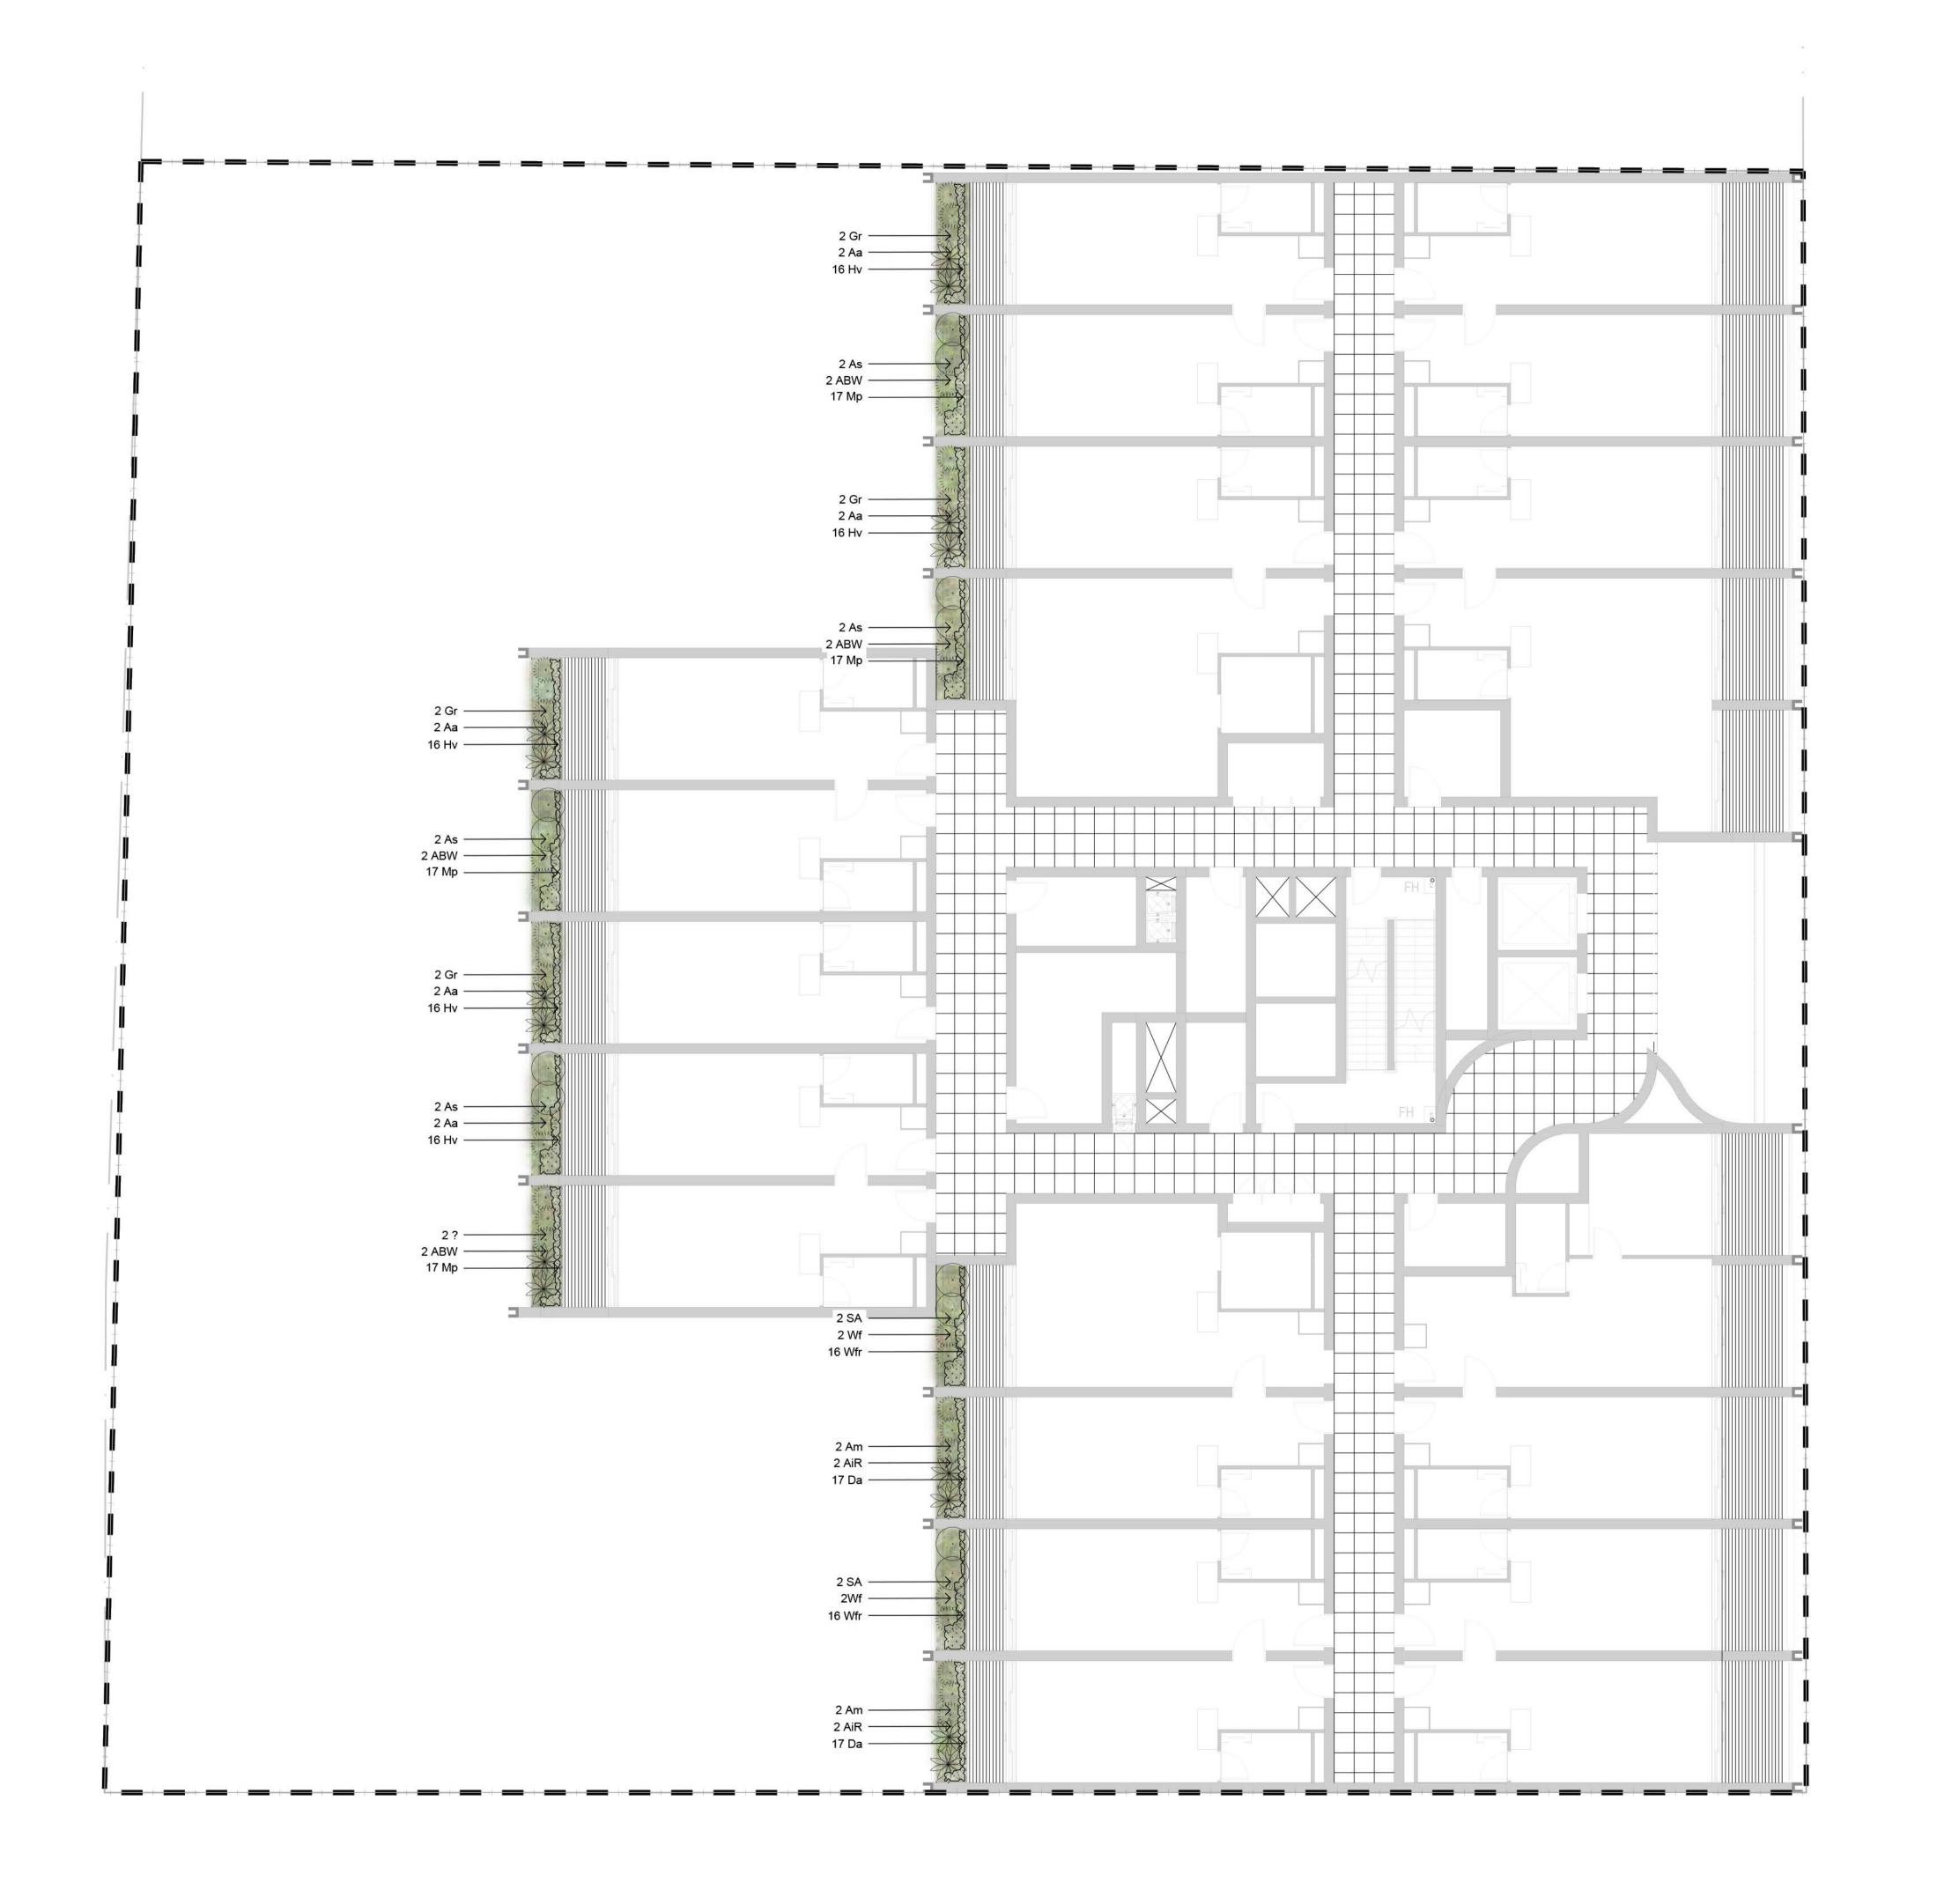

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F Architectural Coordination **Development Application**

LW NM 23.11.2022 LW NM 01.07.2022

Development Application


RH NM 02.12.2021 LW NM 16.11.2021 Architectural Coodination B Development Application LW NM 10.11.2021 A Draft Development Application RH NM 05.11.2021


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Legend


Issue Revision Description





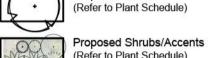

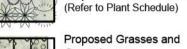Proposed Grasses and Groundcovers (Refer to Plant Schedule)

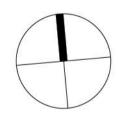

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SITE IMAGE


DEVELOPMENT APPLICATION

Landscape Plan

Level 2

SS21-4805

103 F

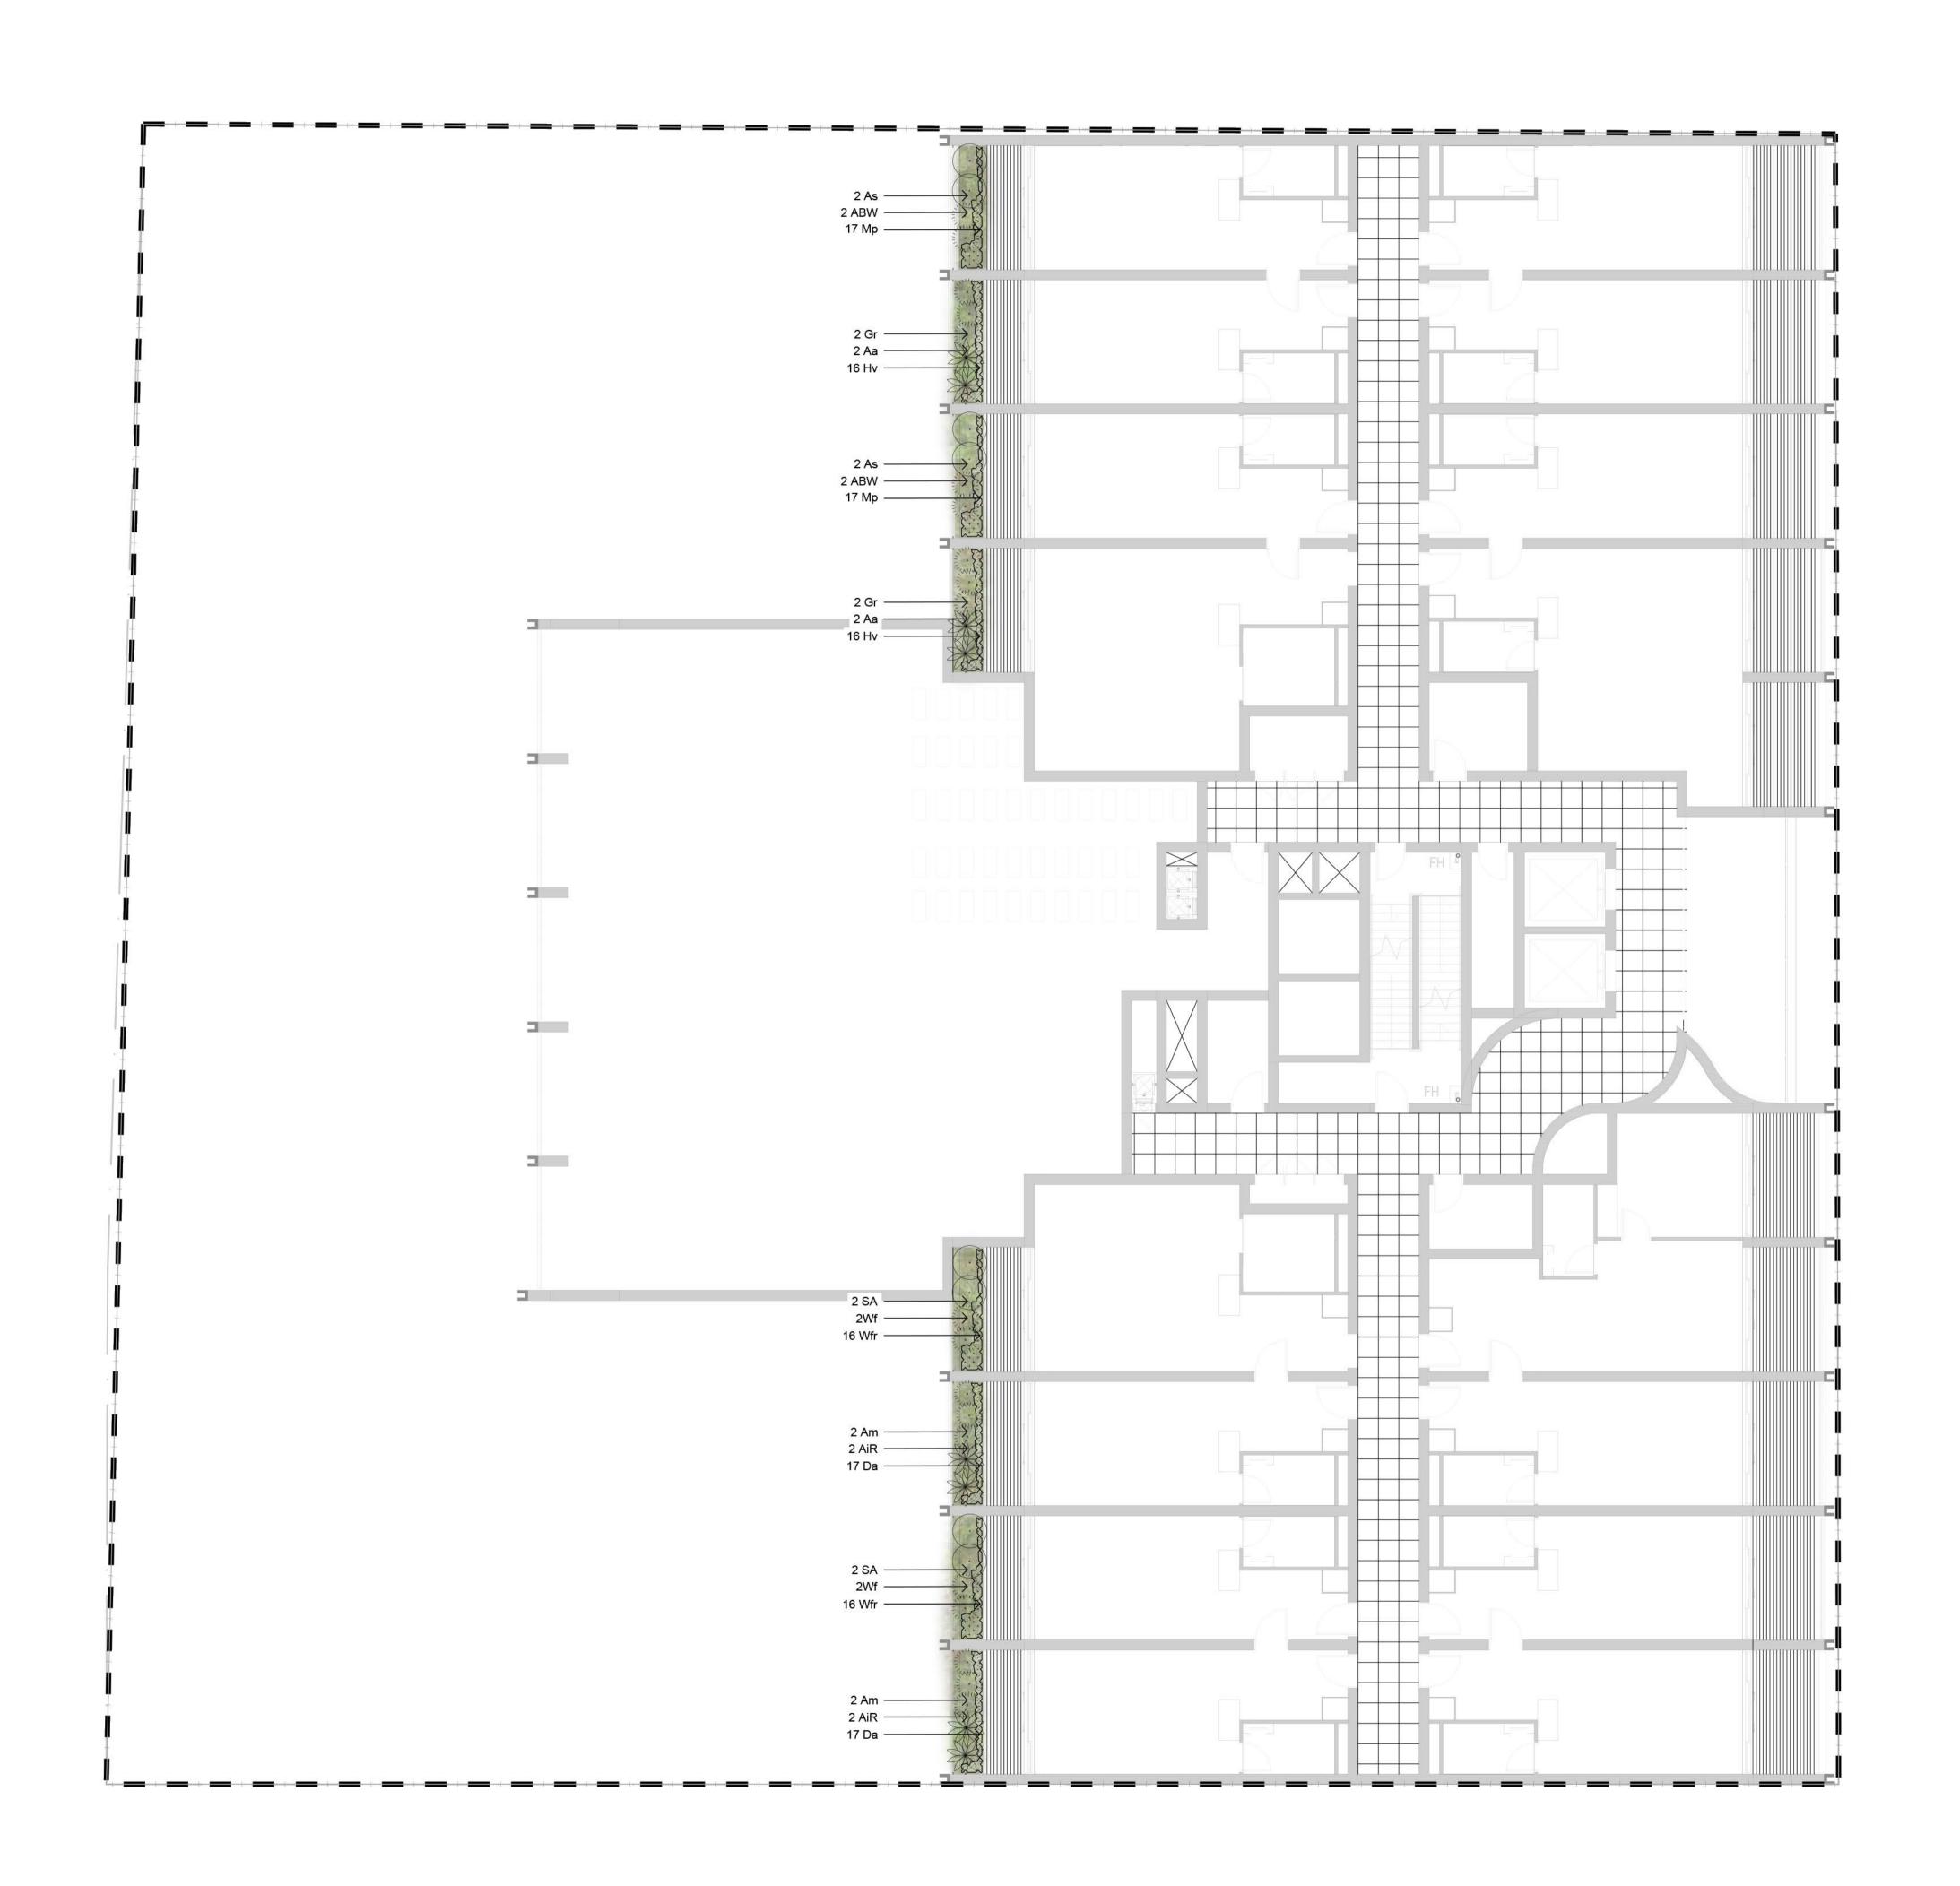

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F Architectural Coordination E Development Application

Issue Revision Description

LW NM 23.11.2022 LW NM 01.07.2022 RH NM 02.12.2021

Development Application Architectural Coodination

LW NM 16.11.2021 B Development Application LW NM 10.11.2021 A Draft Development Application RH NM 05.11.2021

Drawn Check Date

Legend






(Refer to Plant Schedule) Proposed Shrubs/Accents (Refer to Plant Schedule)



Proposed Grasses and Groundcovers (Refer to Plant Schedule)

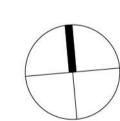

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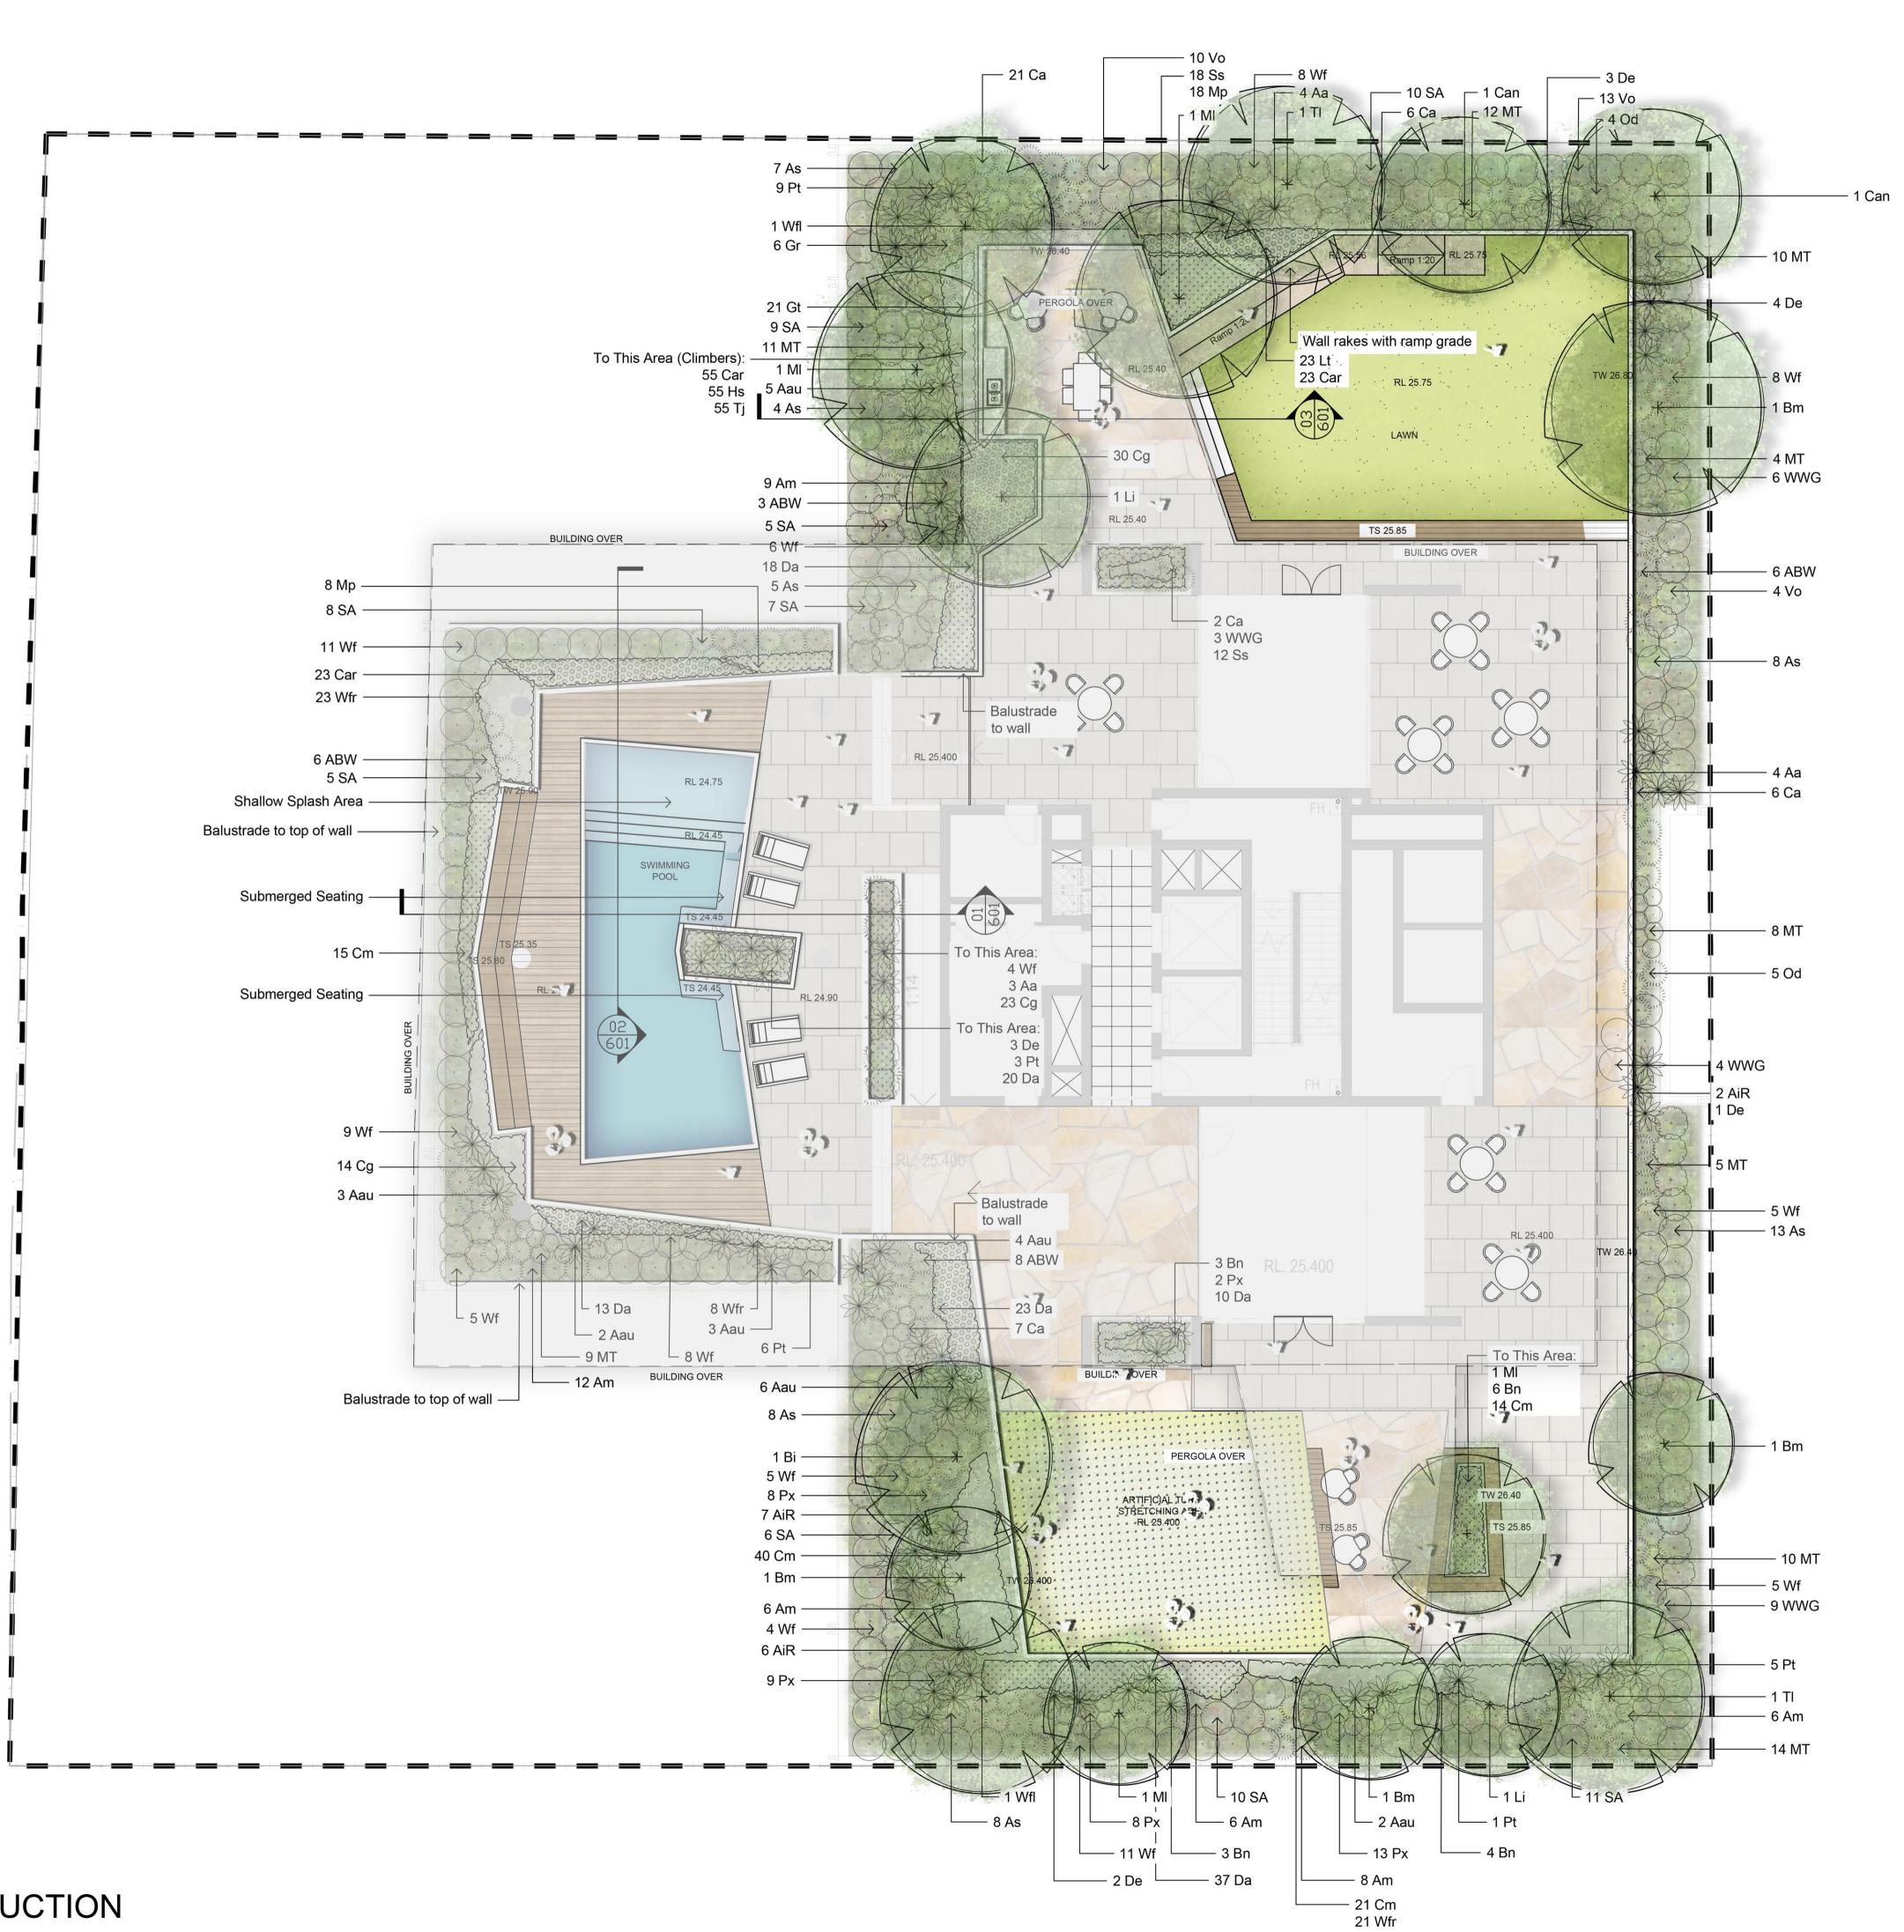
SITE IMAGE

DEVELOPMENT APPLICATION

Landscape Plan


Level 3

104 F



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LW NM 23.11.2022

Units Paving

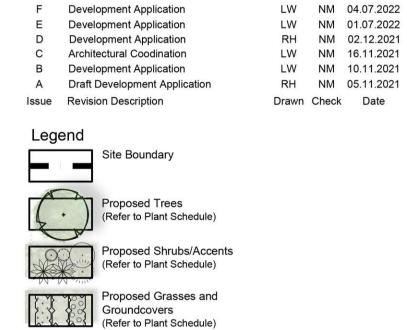
G Architectural Coordination

Sun Lounger

Outdoor Dinning Table and

Amphitheatre Seat

Artificial Turf

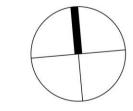

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105 G

DEVELOPMENT APPLICATION

Drawing Name

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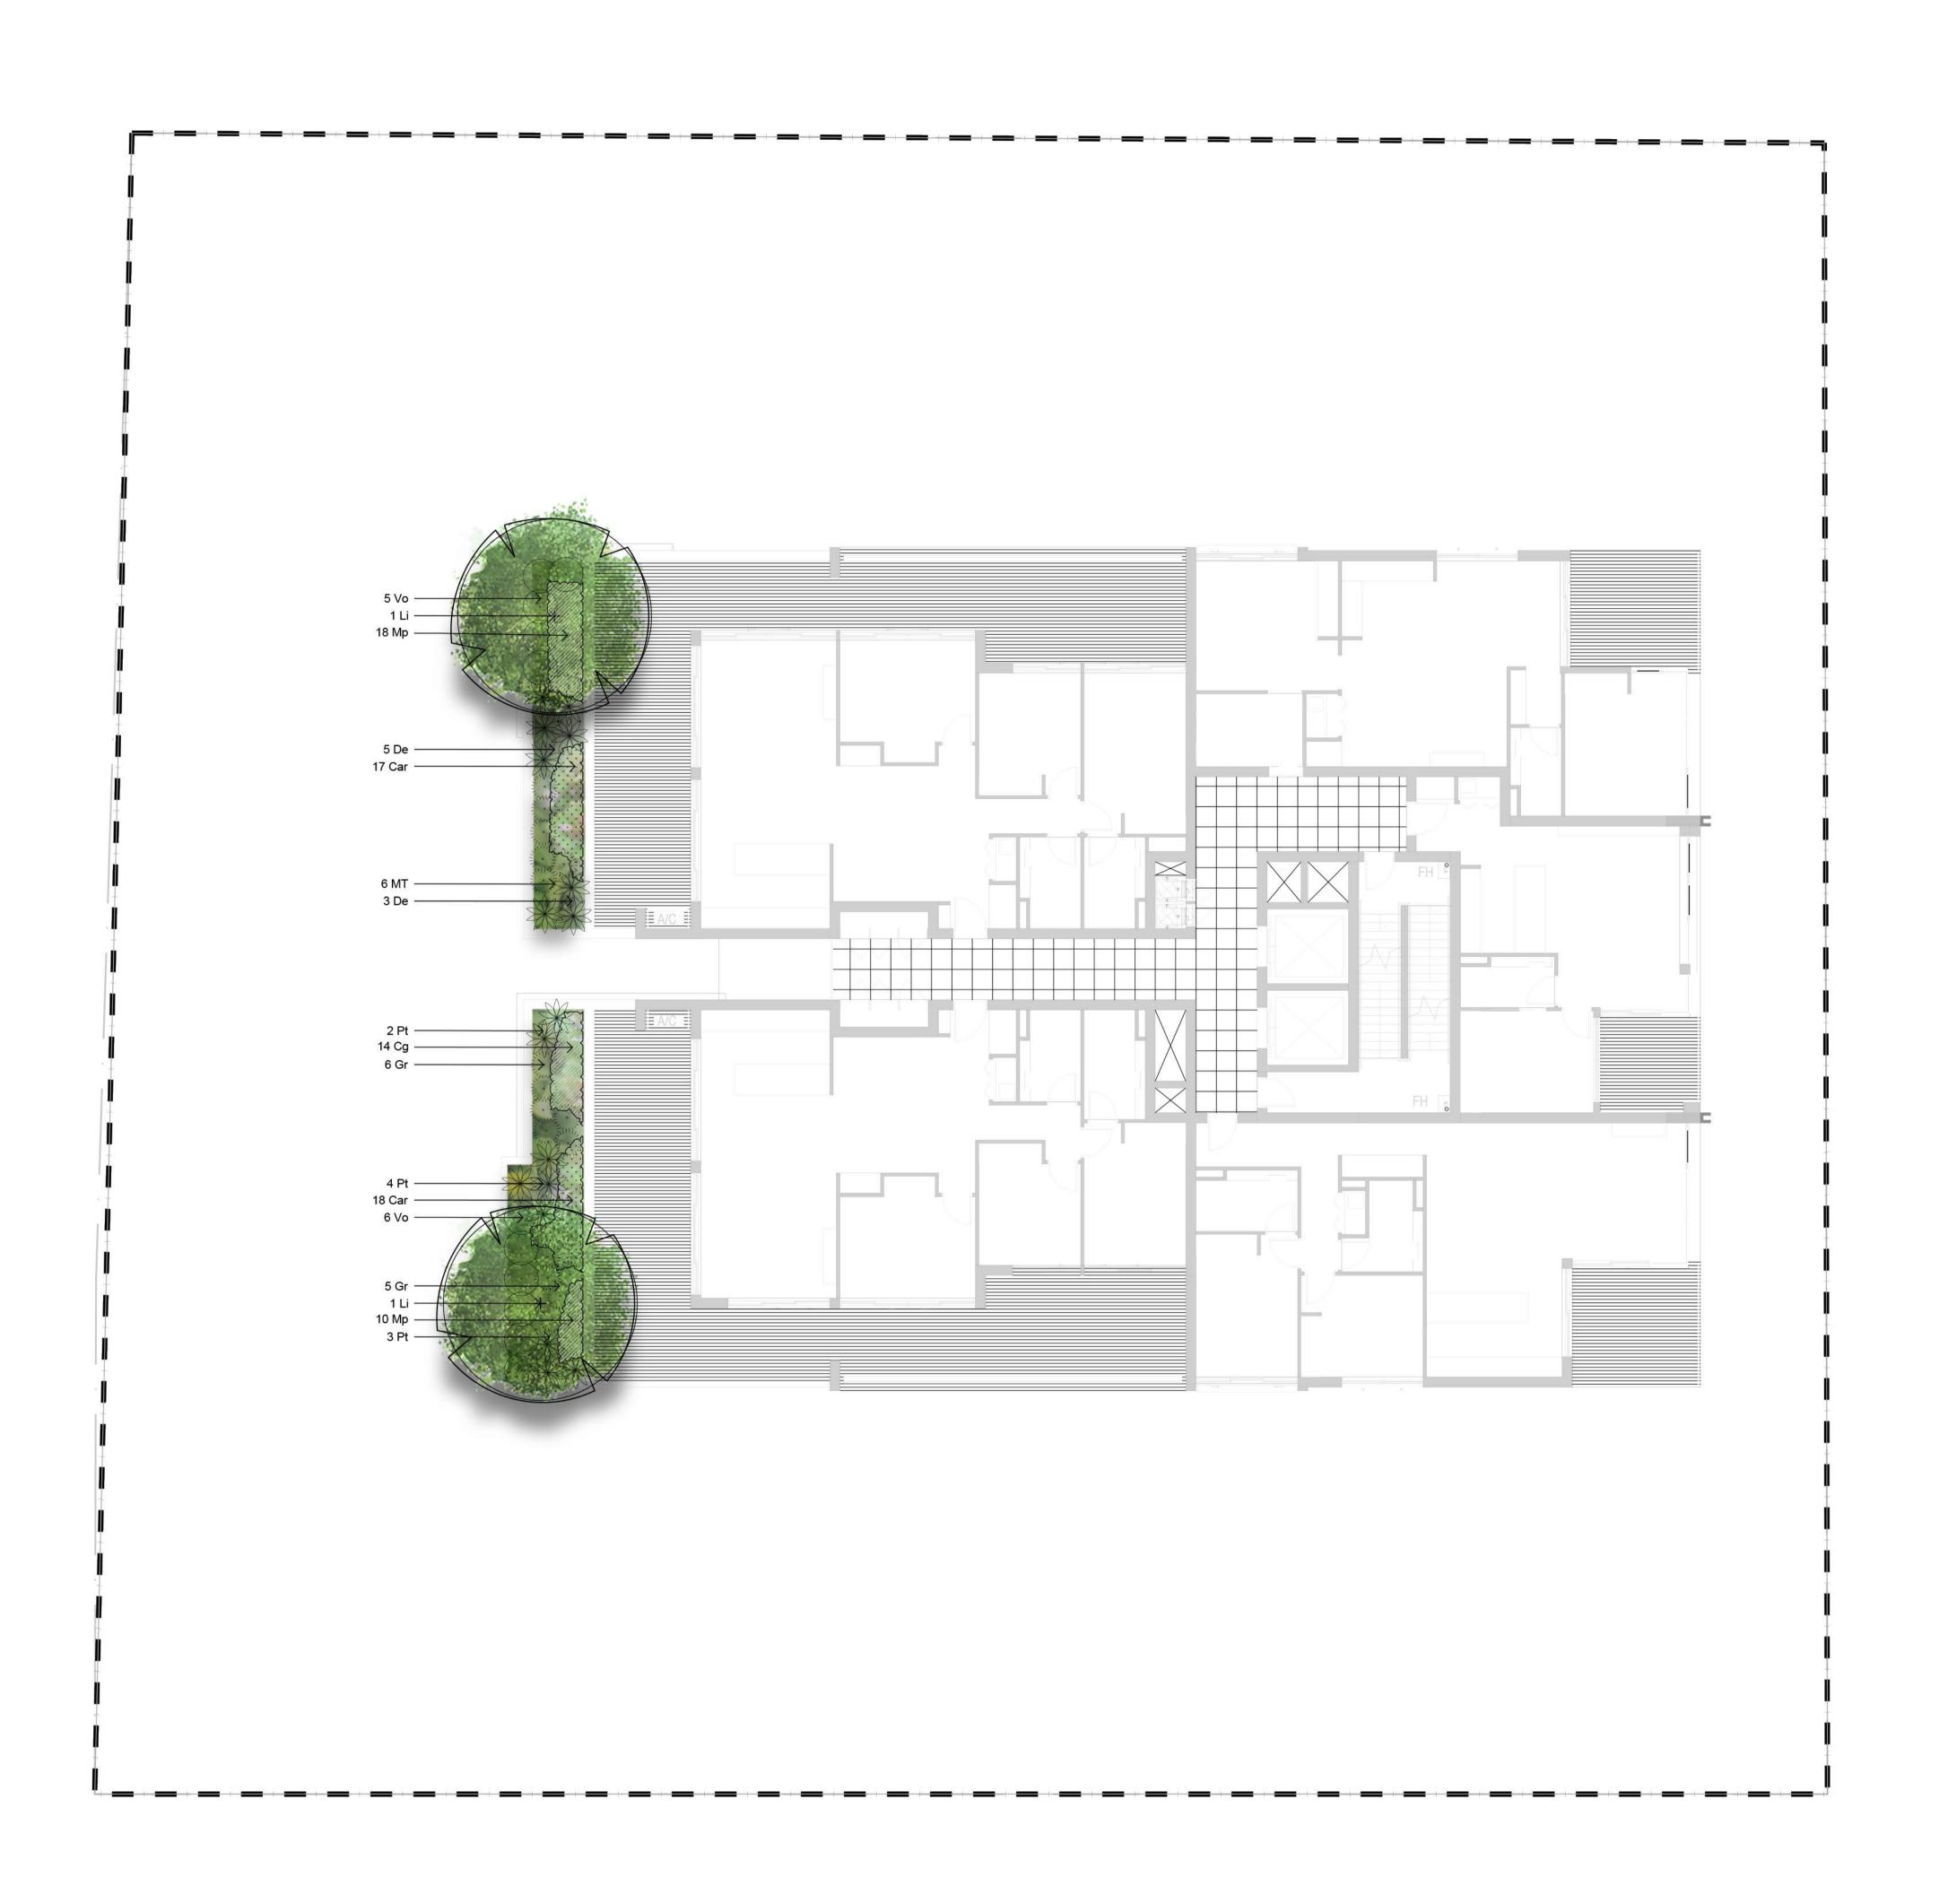
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Landscape Plan

Level 4

Scale 1:100 @ A1

SS21-4805



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E Architectural Coordination LW NM 23.11.2022 LW NM 01.07.2022 D Development Application RH NM 02.12.2021 C Development Application

B Development Application LW NM 10.11.2021 A Draft Development Application RH NM 05.11.2021 Issue Revision Description Drawn Check Date

Legend






(Refer to Plant Schedule) Proposed Shrubs/Accents (Refer to Plant Schedule)



Proposed Grasses and Groundcovers (Refer to Plant Schedule)

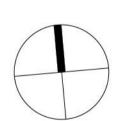

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SITE IMAGE


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DEVELOPMENT APPLICATION

Landscape Plan

Level 14

SS21-4805

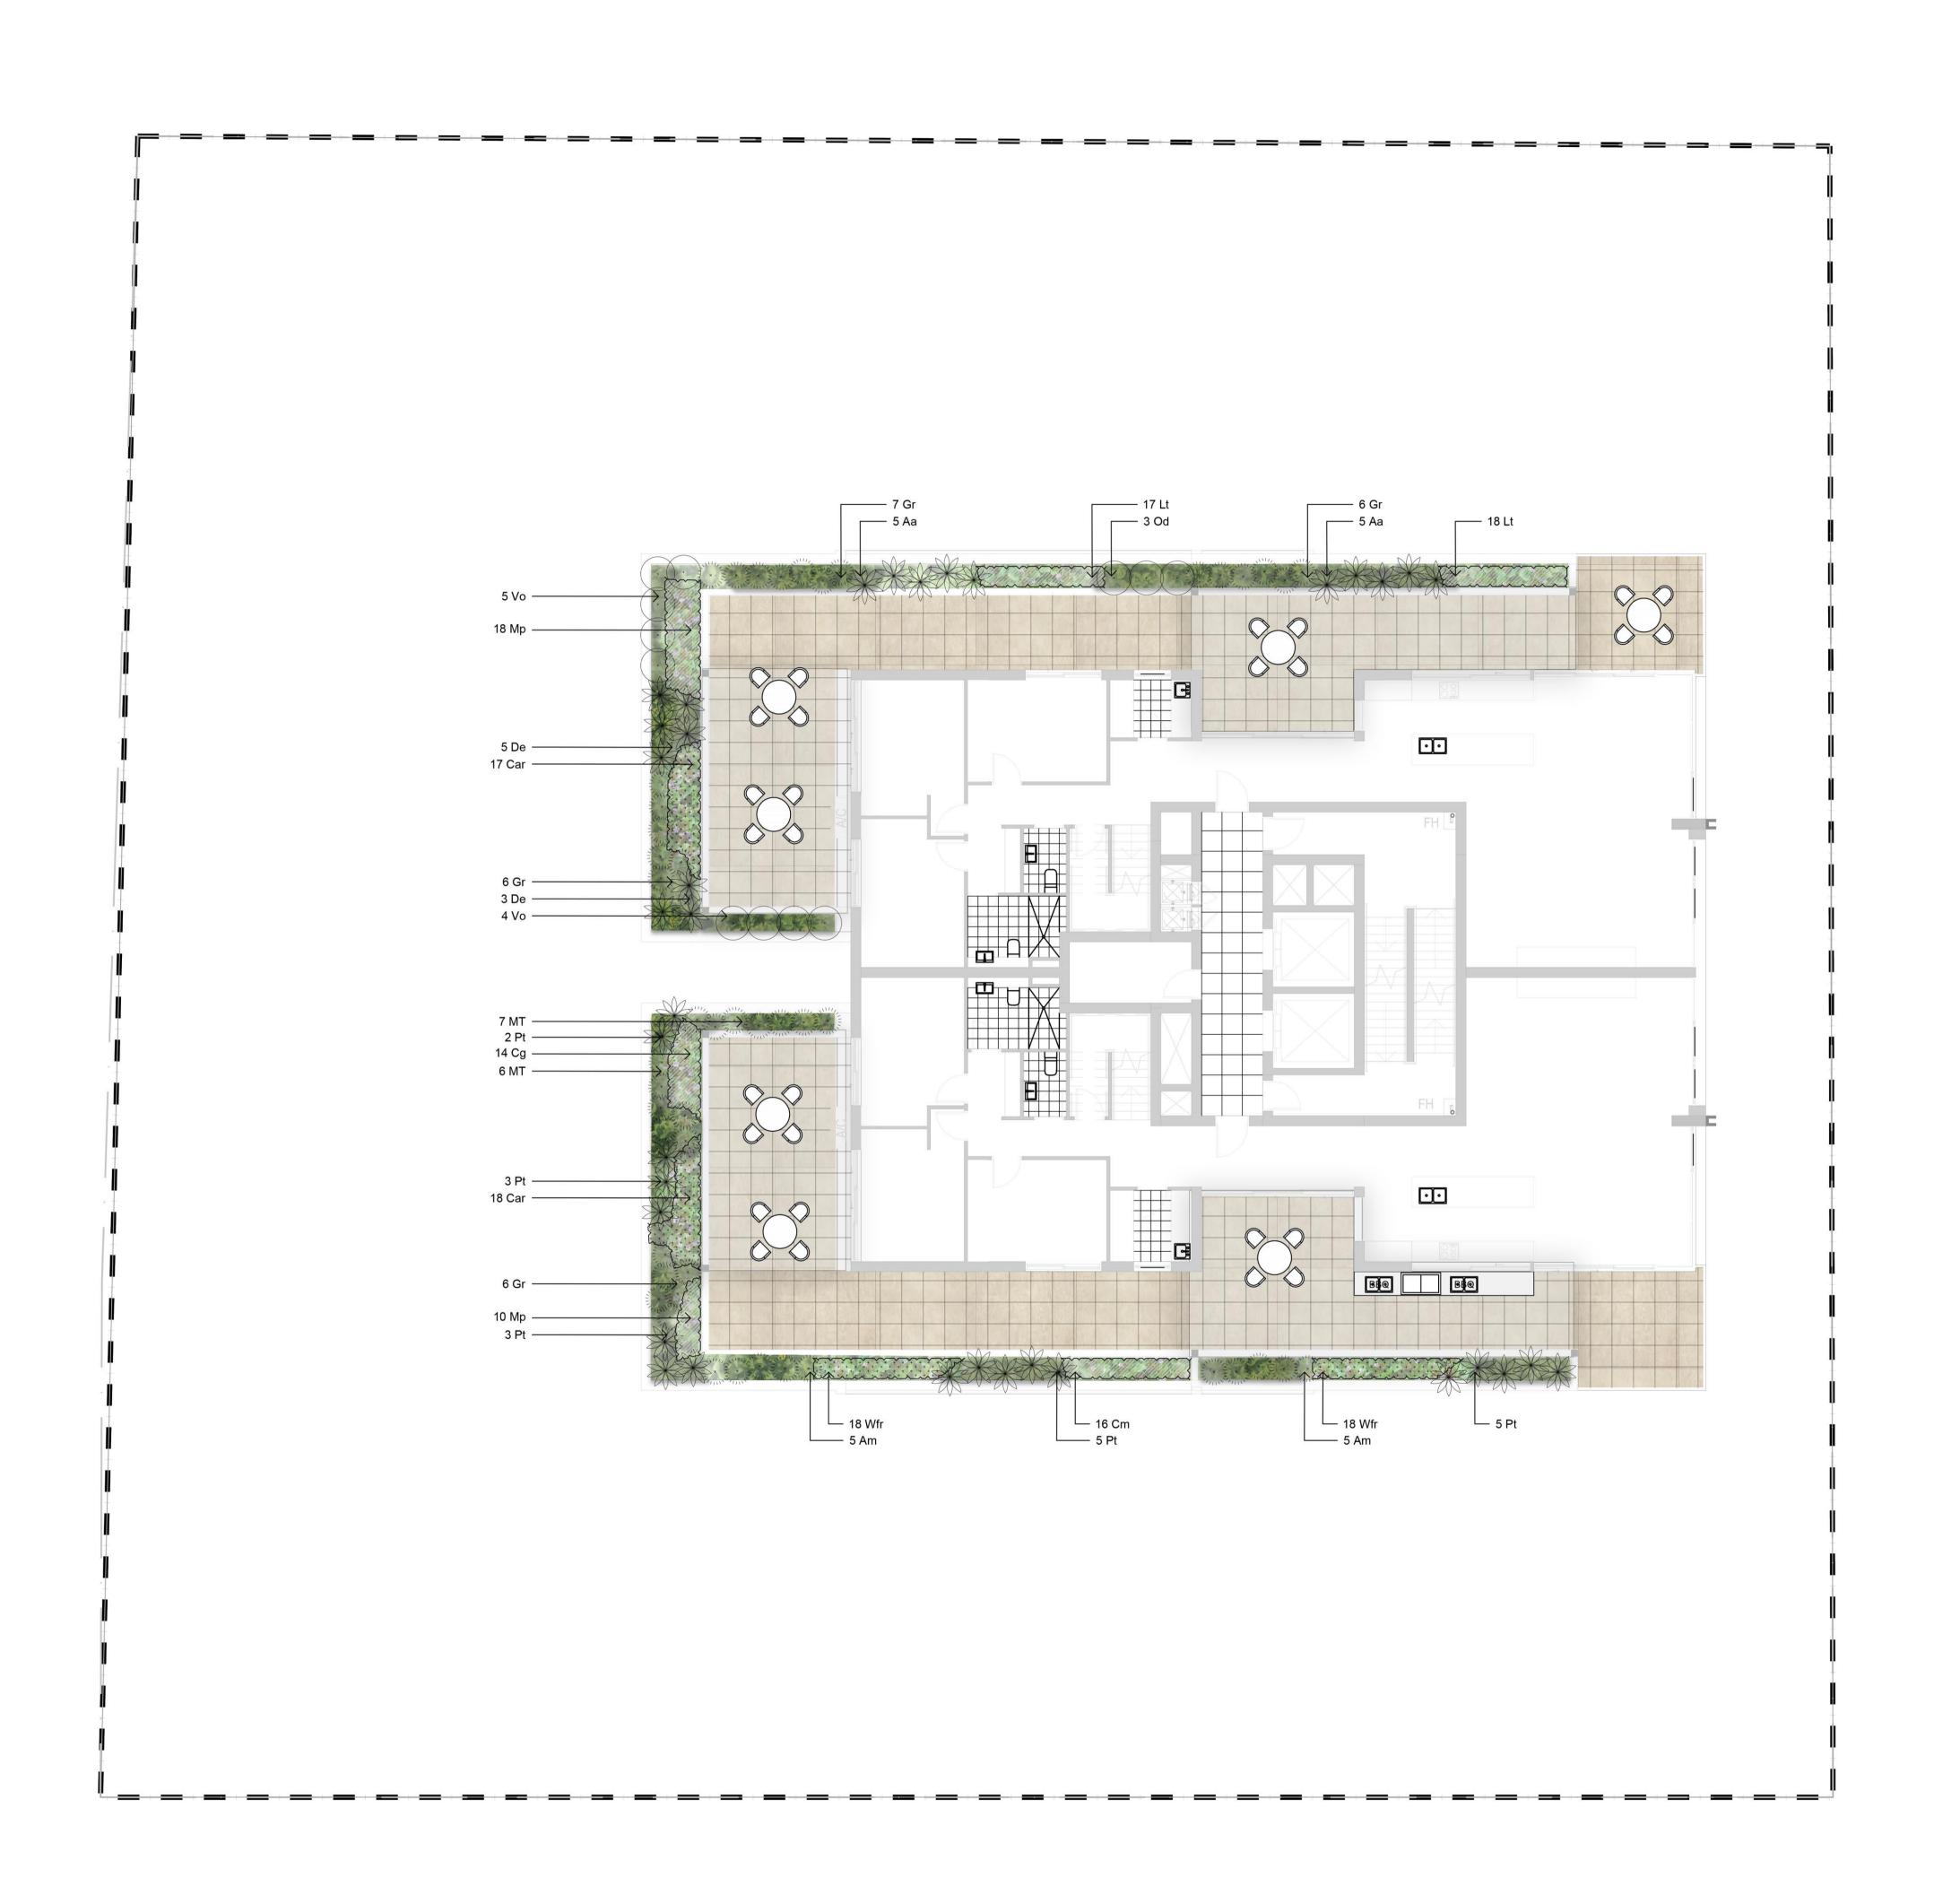


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D Architectural Coordination **Development Application Development Application** A Draft Development Application

LW NM 23.11.2022 RH NM 02.12.2021 LW NM 10.11.2021 RH NM 05.11.2021 Drawn Check Date

Legend



Issue Revision Description

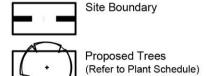Proposed Trees



Proposed Shrubs/Accents (Refer to Plant Schedule)



Proposed Grasses and Groundcovers (Refer to Plant Schedule)



Fire Pit & Chairs





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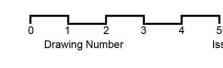
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DEVELOPMENT APPLICATION

Drawing Name

Landscape Plan

Level 16



SS21-4805

Ground floor



Street tree planting - Eleocarpus reticulatus (as per public domain manual)



Urbanstone Gunmetal (dark grey) public domain paving. Option to continue material into lobby


Level 1



Recycled sleeper seat



Porphyry paving to edge of turf

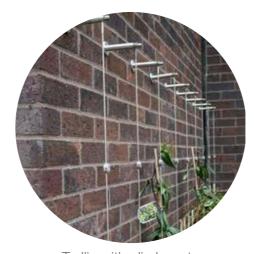

Trellis with climbers to soften wall



Plunge Pool/ Spa



Multi-purpose artificial turf

Level 4



Flexible use lawn/ stretching area



Passive seating to communal garden



Undercroft pool with submerged seating



Pergola over Communal BBQ area



Textural planting

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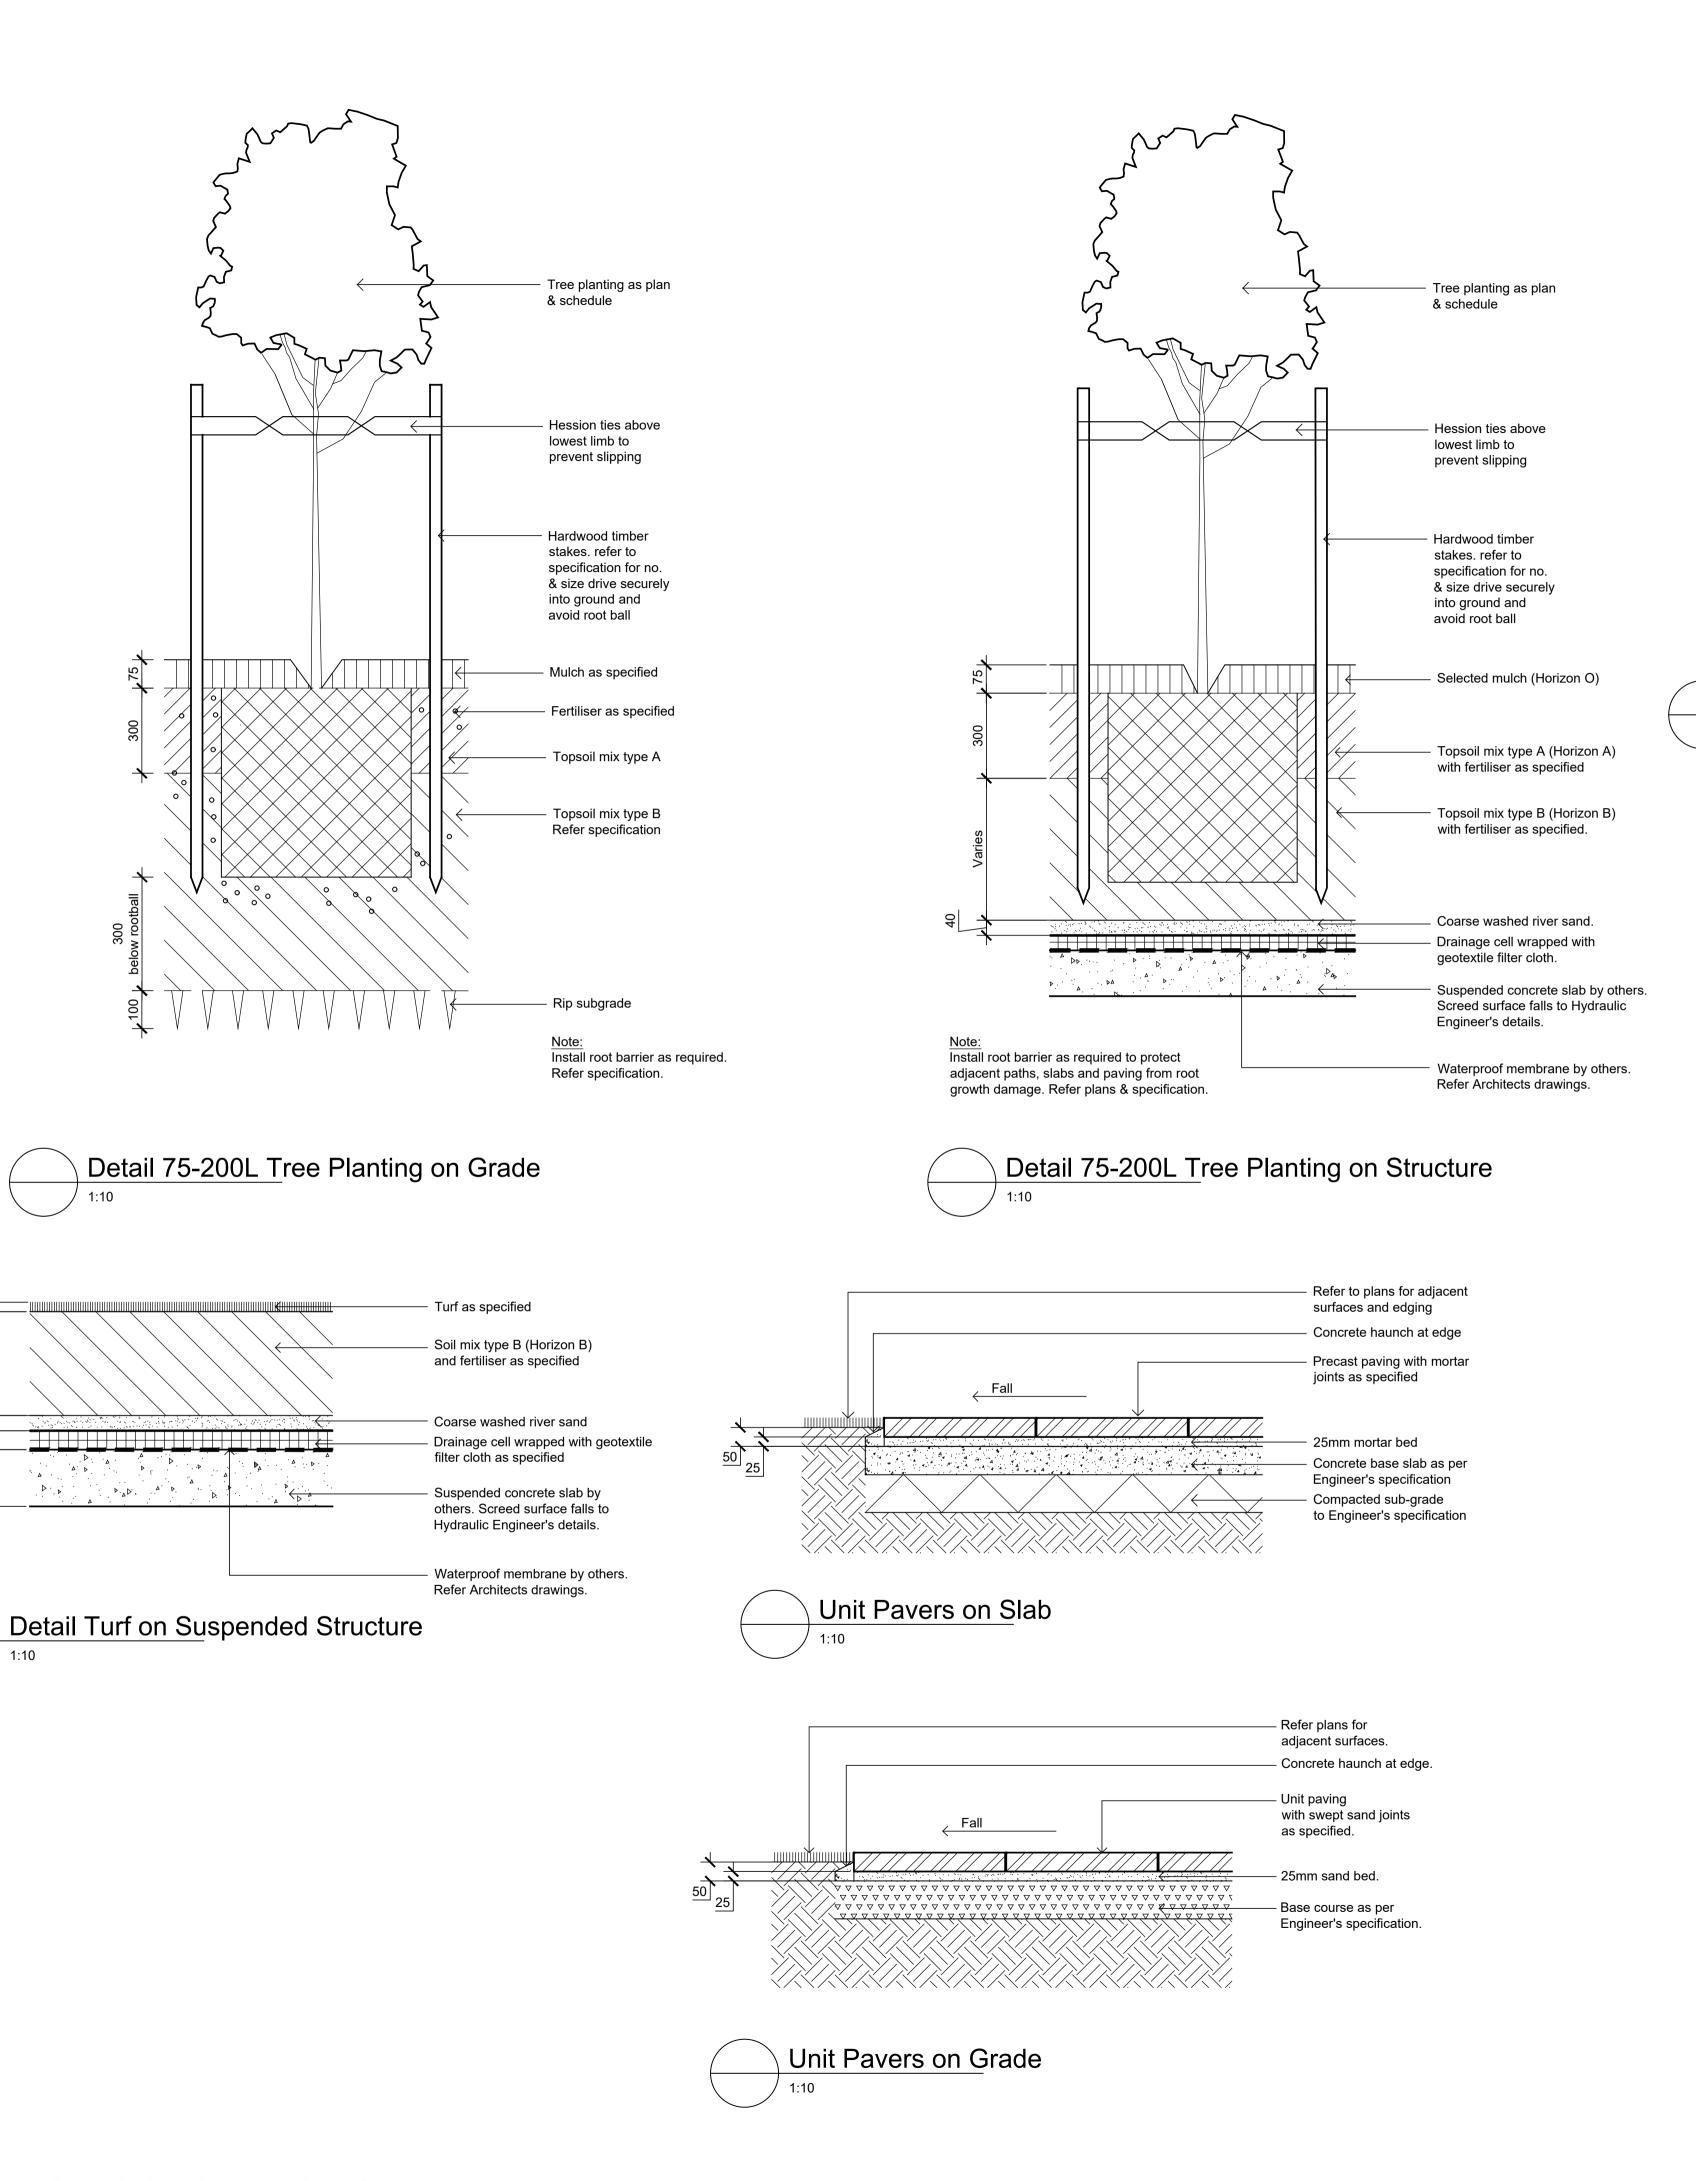
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DEVELOPMENT APPLICATION

Landscape Character

500 F SS21-4805



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> Standard Detail Update Draft Development Application

LW NM 10.11.2021 RH NM 05.11.2021 Issue Revision Description Drawn Check Date Legend

Shrub, accent & groundcover planting refer plan & schedule

- Mulch as specified

Refer specification

- Soil mix type A

Soil mix type B

cloth as specified

Suspended concrete slab by

Coarse washed river sand

Drainage cell & geotextile filter

others. Screed surface falls

Waterproof membrane.

Refer Architects drawings


to Hydraulic Engineer's details.

- Fertiliser

 \Box

Detail Shrub Accent & Groundcover Planting on Structure

Key Plan

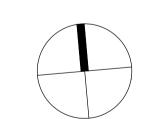

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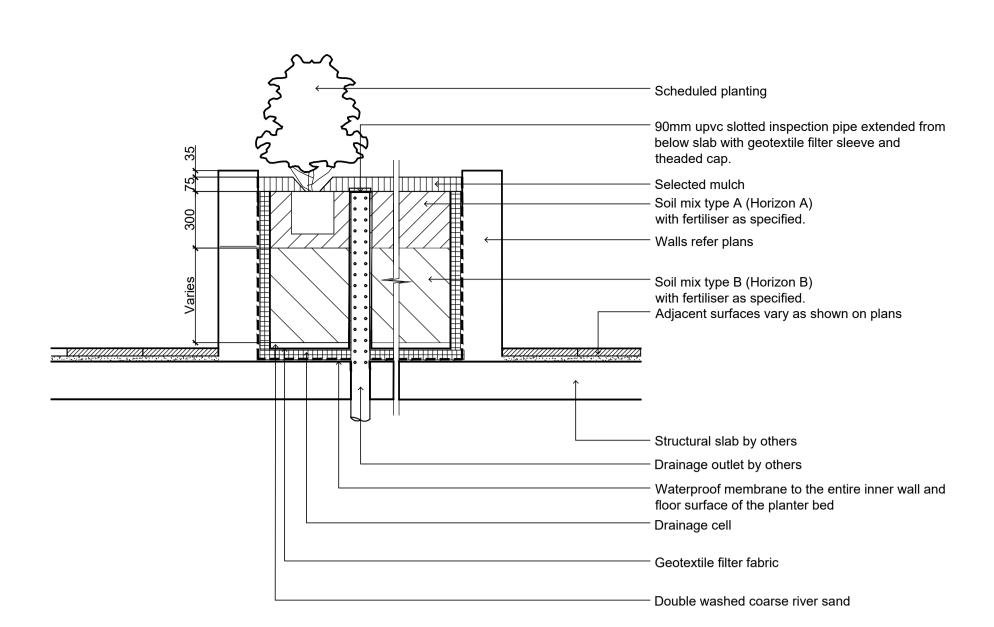
DEVELOPMENT APPLICATION

Drawing Name Landscape Details


SS21-4805

501 B


Landscape Architects






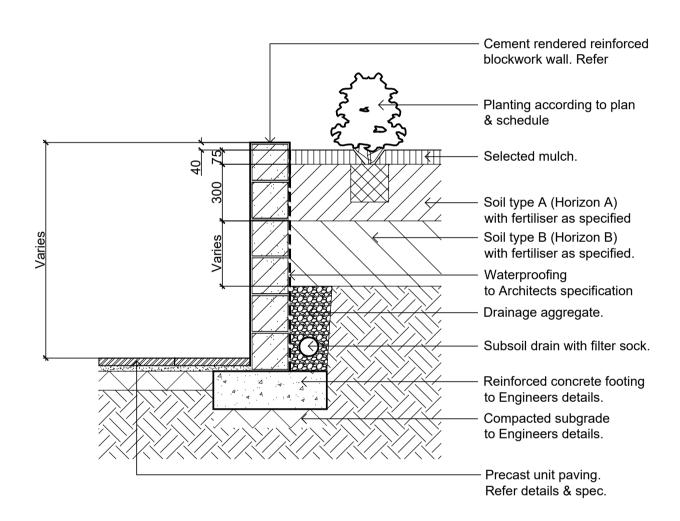

Section - Typical Raised Planter Bed

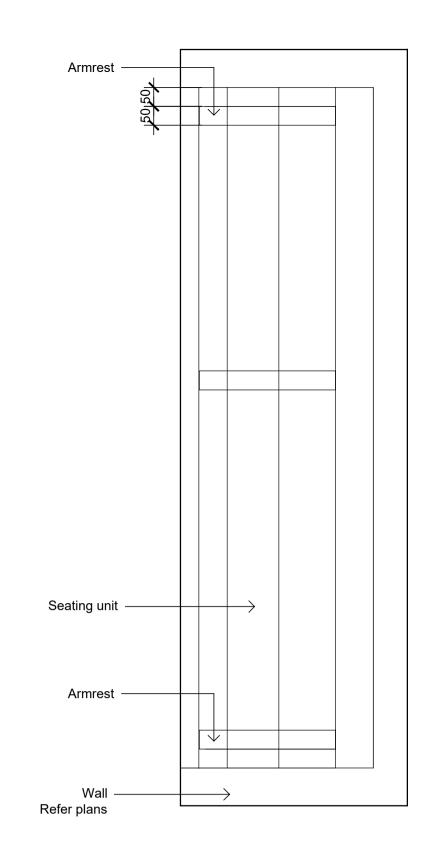

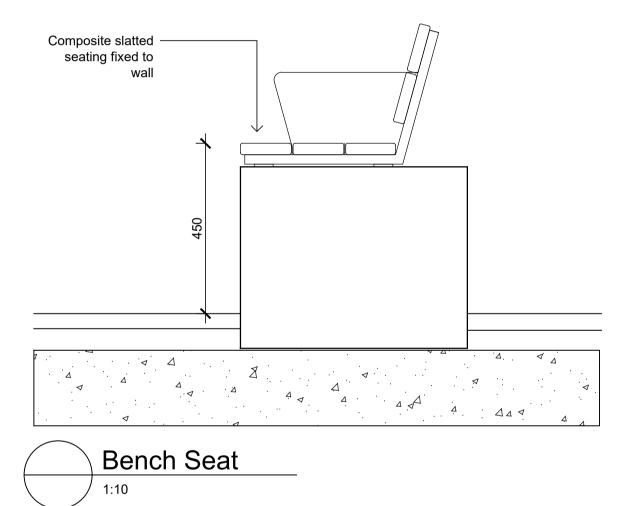

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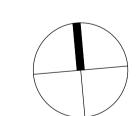
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B Standard Detail Update A Draft Development Application Issue Revision Description

LW NM 10.11.2021 RH NM 05.11.2021 Drawn Check Date

Legend

Key Plan



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Landscape Architects


DEVELOPMENT APPLICATION

Landscape Details

Job Number 502 B

SS21-4805

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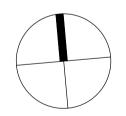
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B Architectural Coordination A Draft Development Application

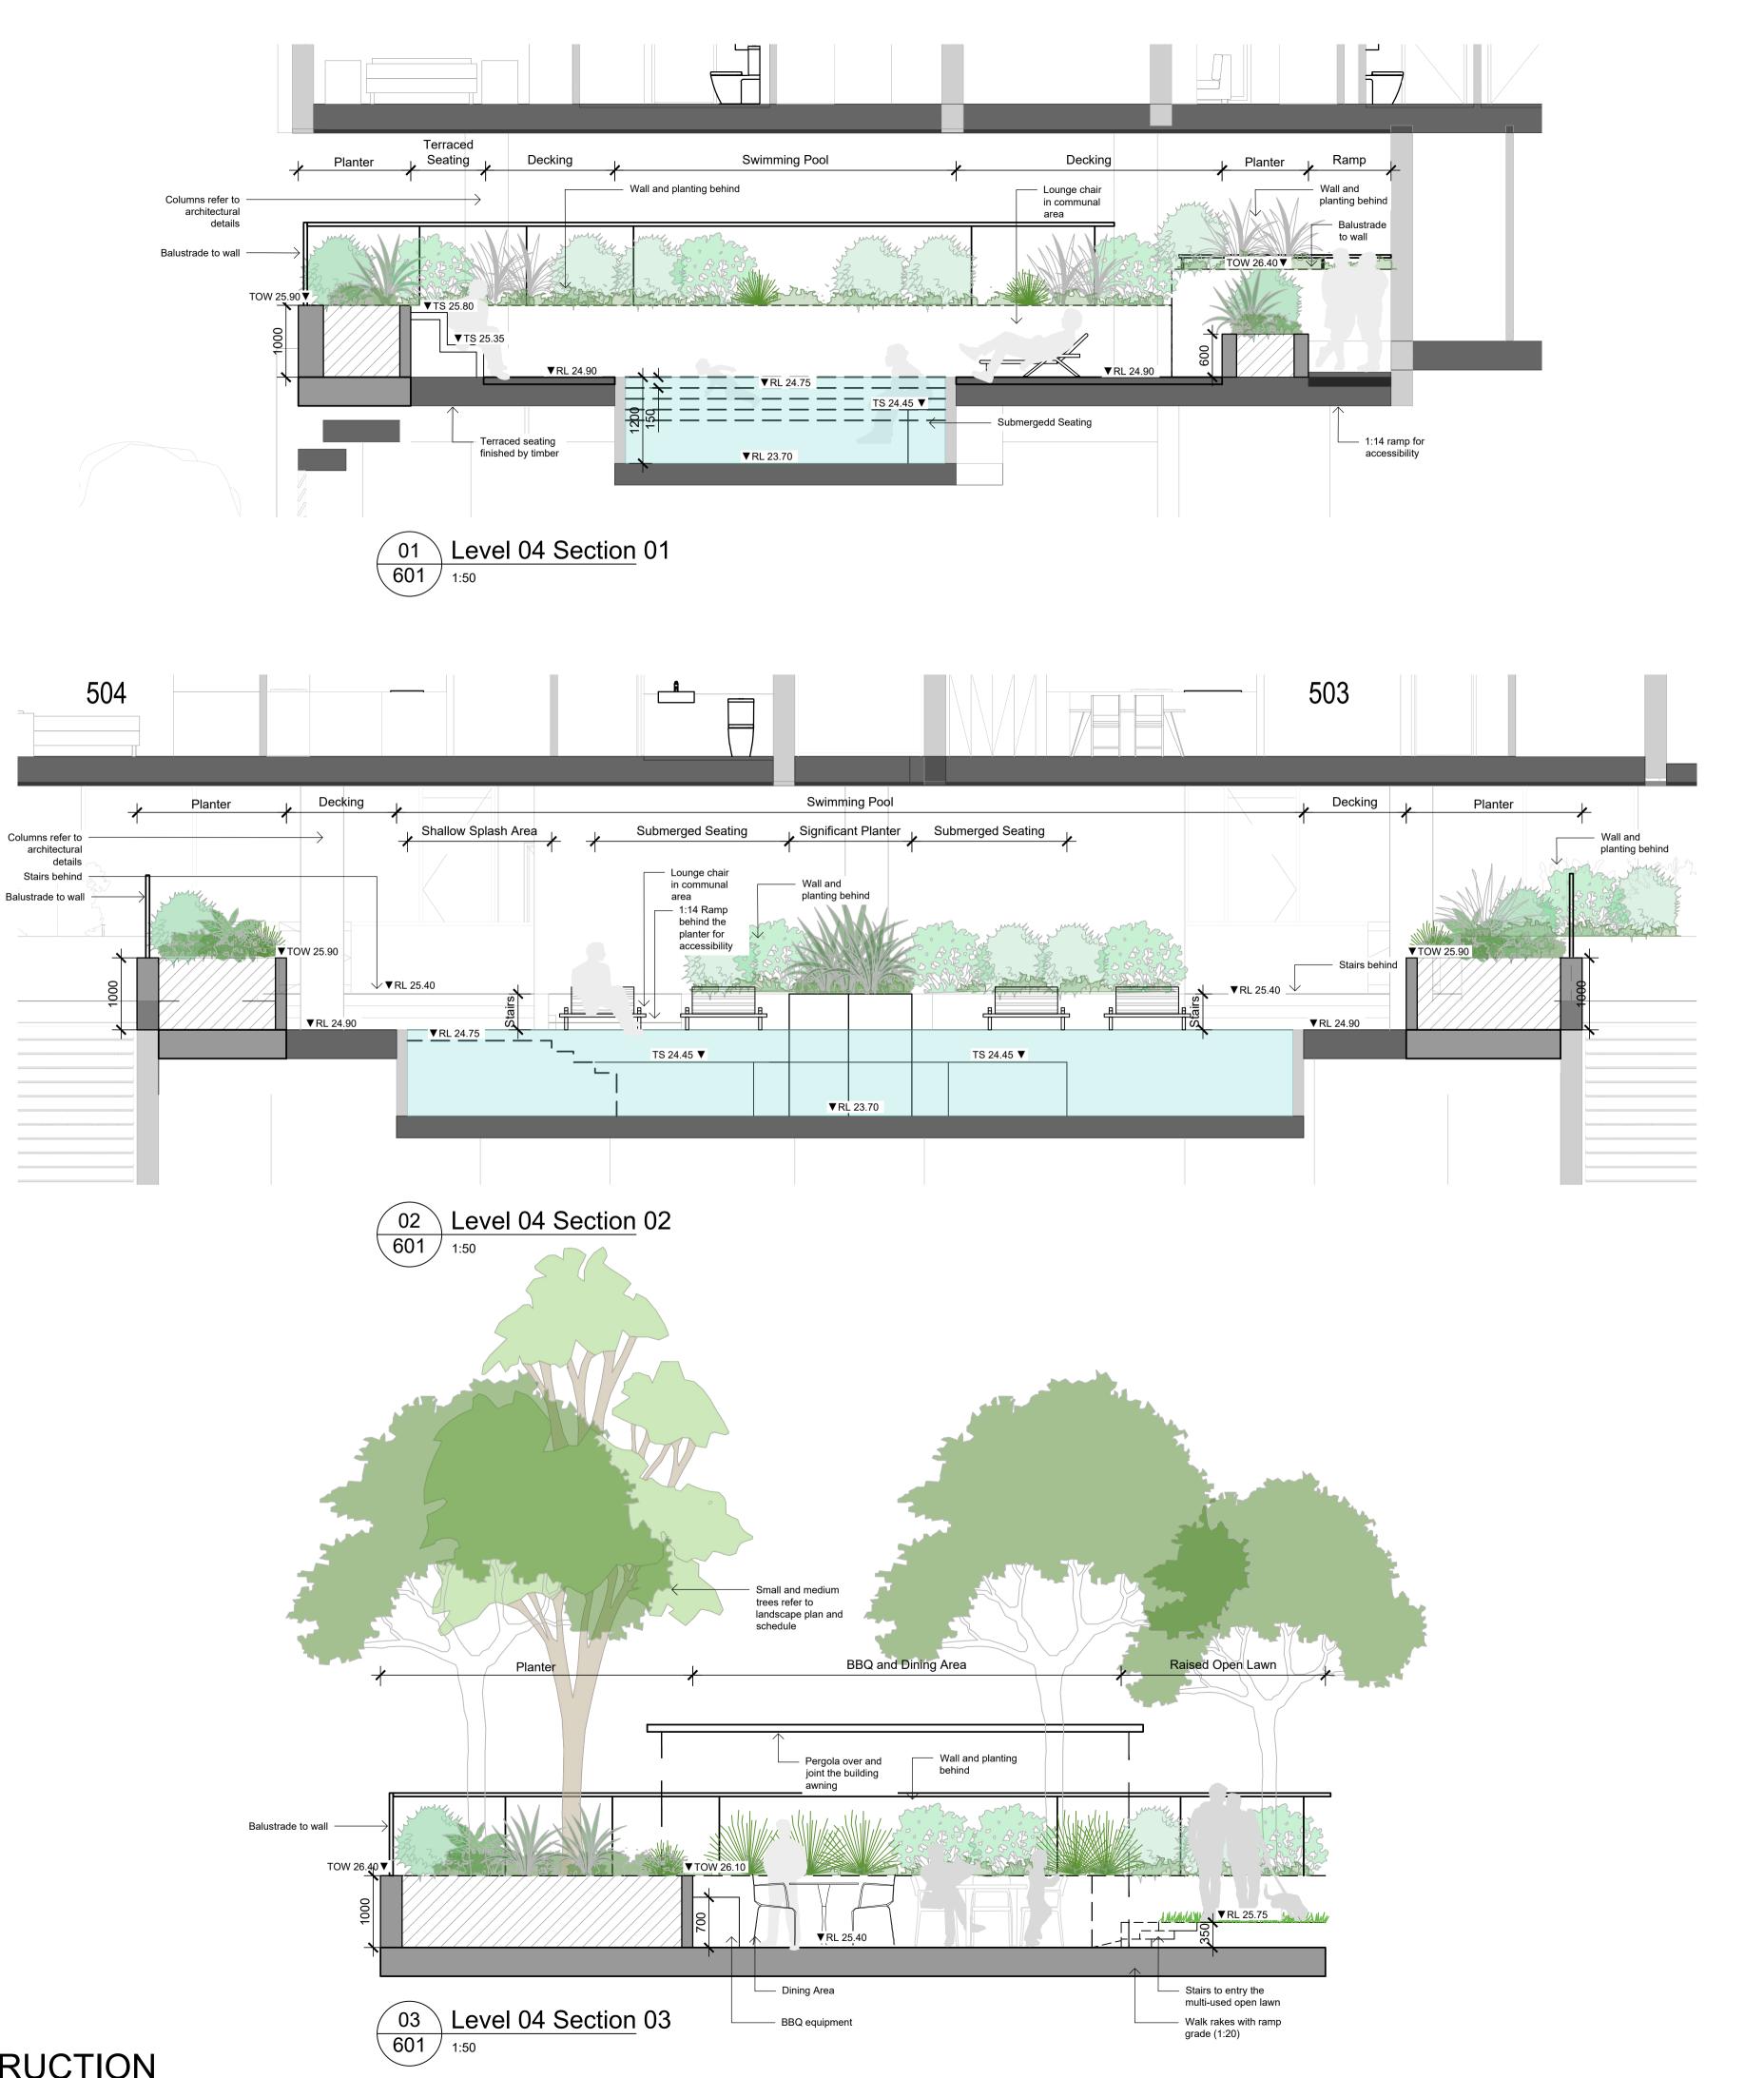Issue Revision Description

LW NM 23.11.2022 RH NM 05.11.2021 Drawn Check Date

Legend



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DEVELOPMENT APPLICATION

Landscape Sections

Scale As Shown

Job Number 601 B

SS21-4805

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